WARKWORTH SOUTH PLAN CHANGE - WAIMANAWA URBAN DESIGN REPORT

On behalf of KA-Waimanawa Limited Partnership & Stepping Towards Far Limited

May 2023







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1. INTRODUCTION

1.1 Overall

Reset Urban Design has been engaged by KA-Waimanawa Limited Partnership and Stepping Towards Far Limited to provide a masterplan for a proposed Private Plan Change for the site known as Waimanawa in Warkworth. The site comprises a number of properties on the southern side of the township of Warkworth. Together with Osbornehay, Tattico, Maven Associates, Traffic Planning Consultants and other expert consultants, our multi-discipline team has been working collaboratively to develop a comprehensive masterplan that demonstrates the feasibility of the proposed urban development.

Preliminary consultation meetings have been held over a 18 month period with Auckland Council, Supporting Growth, Ngati Manuhiri - the Mana Whenua, the local community board and the adjoining landowners as part of the consultation process.

1.2 Scope and Report Structure

The purpose of this document is to provide a thorough design process and an indicative masterplan layout for the site. It is intended to outline the design rationale and demonstrate a possible subdivision layout to assist in demonstrating the suitability of zoning for the site and the urban structure proposed.

A comprehensive approach is undertaken to conduct masterplanning process throughout the Plan Change area. Building on the vision of being site responsive, this report sets out the relevant planning and strategic context from an urban design perspective. Followed by a series of site analyses, Section 4 sets out the vision and overarching goals, with Section 5 providing an urban design framework for Waimanawa including key design principles, structure of the masterplan and an overall masterplan.

The masterplan has been illustrated through two separate sections that provides key design rationale and details on masterplan layout.

1.3 Masterplan Area

The masterplan area ('the site') incorporates all the land identified as 'Waimanawa' subject to the Private Plan Change. The site comprises two main parts, being 'Waimanawa Valley' to the west of State Highway1 and 'Waimanawa Hills' to the east of State Highway. (Figure 2 shows the area subject to the plan change request)

Waimanawa Valley comprises approximately 99.5 hectare of land stretching along the upper reaches of Mahurangi River (right branch) between State Highway 1 and Valerie Close. Morrison Heritage Orchard is identified as part of Waimanawa Valley for the purpose of this report and is not to be subject to any form of urban development in respect of this masterplan.

Waimanawa Hills incorporates 65.5 hectare of land between SH1 and Avice Miller Reserve. For the purpose of this report, Waimanawa Hills is further referred as Waimanawa Hills(a), Waimanawa Hills(b) and Waimanawa Hills(c). (Refer to Figure 3)

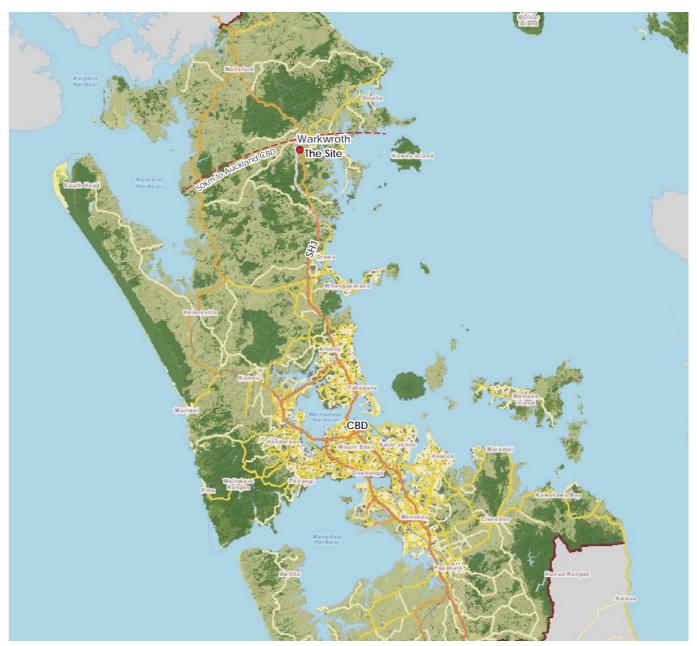


Figure 1 - Plan Change Site Location

Land Subject to the Proposed Plan Change

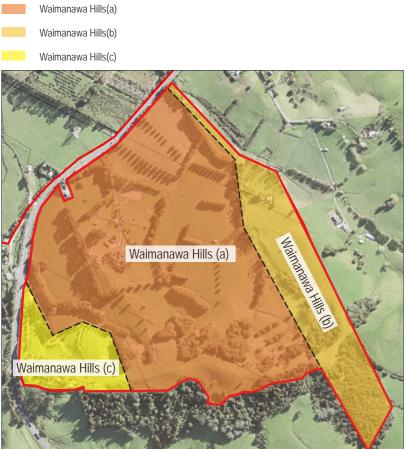


Figure 3 - Waimanawa Hills Areas







Figure 4 - Properties included in Warkworth South Plan Change (by Parallax Surveyors and Planners)

2. CONTEXT INFORMATION

2.1 Strategic context

The Auckland Plan 2050

The Auckland Plan 2050 (June 2018) sets the long-term strategic directions and spatial planning for Auckland to grow over the next 30 years.

Most of Auckland's planned urban growth will have occurred within existing and future urban areas to limit expansion into the rural hinterland. The planned future urban areas will take a quality compact approach to growth and development to ensure these areas are developed in an efficient, cost-effective and sustainable way.

Warkworth, a town in the north of Auckland, will act as a satellite township to provide a range of services to its surrounding rural communities, and also support significant business and residential growth.

With 1100 hectares of land identified for future urban development in Warkworth, significant residential and employment growth is expected in the area. This has the potential to accommodate approximately 7,500 new dwellings.

Figure 7 (below) from the Auckland Plan provides an indicative sequencing for development in Warkworth. The proposed timing for the future urban area in Warkworth South to be development ready is sequenced on the first half of Decade Two (2028-2032), while Warkworth North will be development ready from 2022.

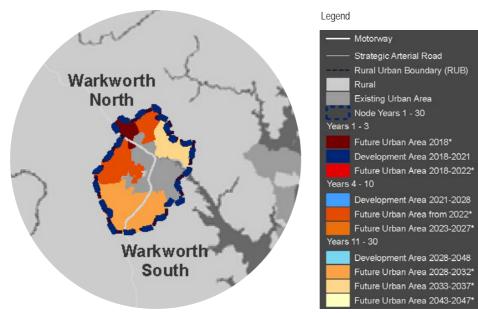


Figure 5 - Sequencing of Future Urban Areas in Warkworth (Source: The Auckland Plan 2050)

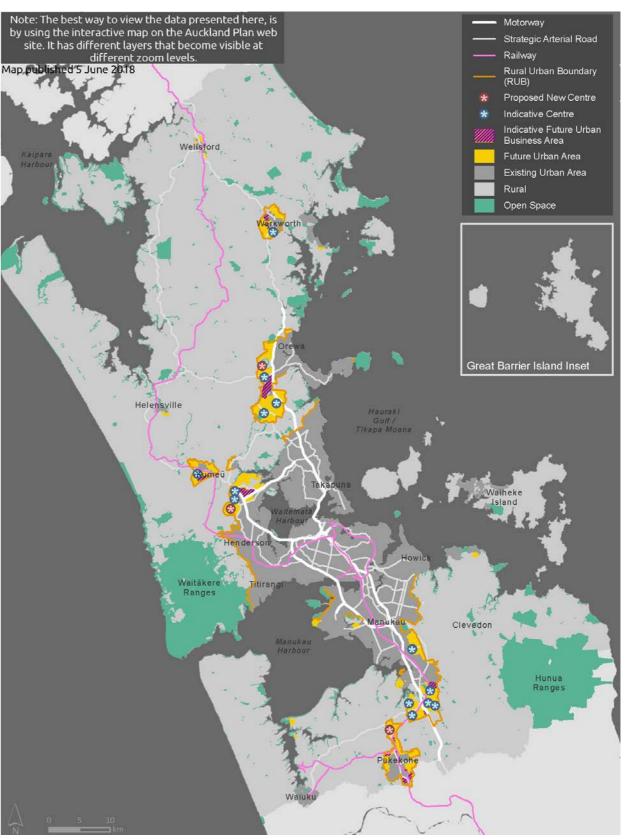


Figure 6 - Auckland Future Urban Areas (Source: The Auckland Plan 2050)

2.2 Planning Context

Auckland Unitary Plan Operative in part (AUP)

Regional Policy Statement

Chapter B2 of the AUP sets out a number of objectives and policies in relation to urban growth and form seeking to achieve a quality compact urban form and provide for a quality built environment.

In particular, the provisions in section B2.2, B2.3, B2.4 and B2.7 are relevant to this plan change in urban design terms.

Policy B2.2.2.(7) sets out that the rezoning of future urban land need to: (a) support a quality compact urban form; (b) provide for a range of housing types and employment choices for the area; (c) integrate with the provision of infrastructure.

In terms of residential growth, the objectives and policies in section B2.4 set out the overarching goal and high-level guide to the residential development within the plan change area. These are summarised below:

- Provide for residential intensification as a primary focus where
 it is in close proximity to centres, public transport corridors, key
 social facilities, open spaces and employment opportunities.
- Provide for a range of built forms and housing types and to meet the diverse demands.
- Residential developments respond to the existing natural and physical environment and is in keeping with the planned neighbourhood characters.

Zoning & Overlays

Under the AUP, the area within the Rural Urban Boundary is currently zoned Future Urban Zone with a small section adjacent to the stream identified as Open Space - Conservation. The portion of land beyond the RUB is zoned Rural - Rural Production Zone. (Refer to zoning map below)

The site is not subject to any outstanding natural features, landscapes or character layers. There are no scheduled trees within the site.

The designation of a new State Highway (Ara Tūhono - Pūhoi to Wellsford Road: Pūhoi to Warkworth Section) runs north south to the west of site along the Rural Urban Boundary.

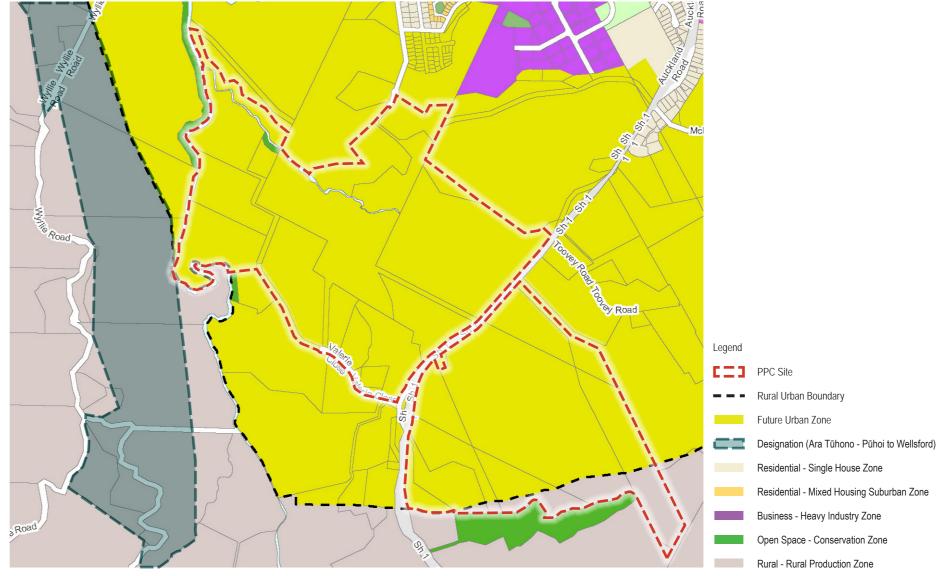


Figure 7 - Auckland Unitary Plan Zones & Designations (Information sourced from Auckland Unitary Plan - Operative in part)

2.3 Structure Plan

Warkworth Structure Plan (June 2019)

The Warkworth Structure Plan ('WSP'), which was adopted in June 2019, sets out the pattern of land use and the supporting infrastructure network for the Future Urban areas in Warkworth. The WSP was produced by Auckland Council through a consultative process involving the public, landowners, Mana Whenua, Auckland Transport, Watercare and Waka Kotahi NZTA.

The vision proposed for Warkworth is:

"Warkworth is a Satellite Town that retains its rural, natural, and cultural character. It is centred around the Mahurangi River and has easy walking and cycling access around the town. There are a variety of high-quality residential neighbourhoods. Warkworth is largely self-sufficient with plenty of employment, education, shopping and recreation opportunities. Transport and other infrastructure are sequenced to support Warkworth's planned growth."

In terms of the masterplan site, some of the key findings identified in the WSP are summarised below:

- New residential areas for more intensive developments (terrace houses and low-rise apartments) are proposed in Warkworth South;
- A new arterial road (Wider Western Link 'WWL') is proposed to connect the existing Stage Highway 1 (SH1) with Woodcocks Road:
- Along with a public transport hub, a new Local Centre ('LC")
 in the south is located in the vicinity of the intersection of the
 existing SH1 and the new arterial road;
- Protection areas in Warkworth south primarily include esplanade reserves along the Mahurangi River or tributaries of the river, wetlands, Significant Ecological Areas and covenanted bush.
- Create 'green corridor' across the urban development to provide protection to the existing natural and ecological values, particularly alongside the Mahurangi River and its tributaries;
- Protect Morrison's Heritage Orchard from subdivision and remains as a rural feature of Warkworth.

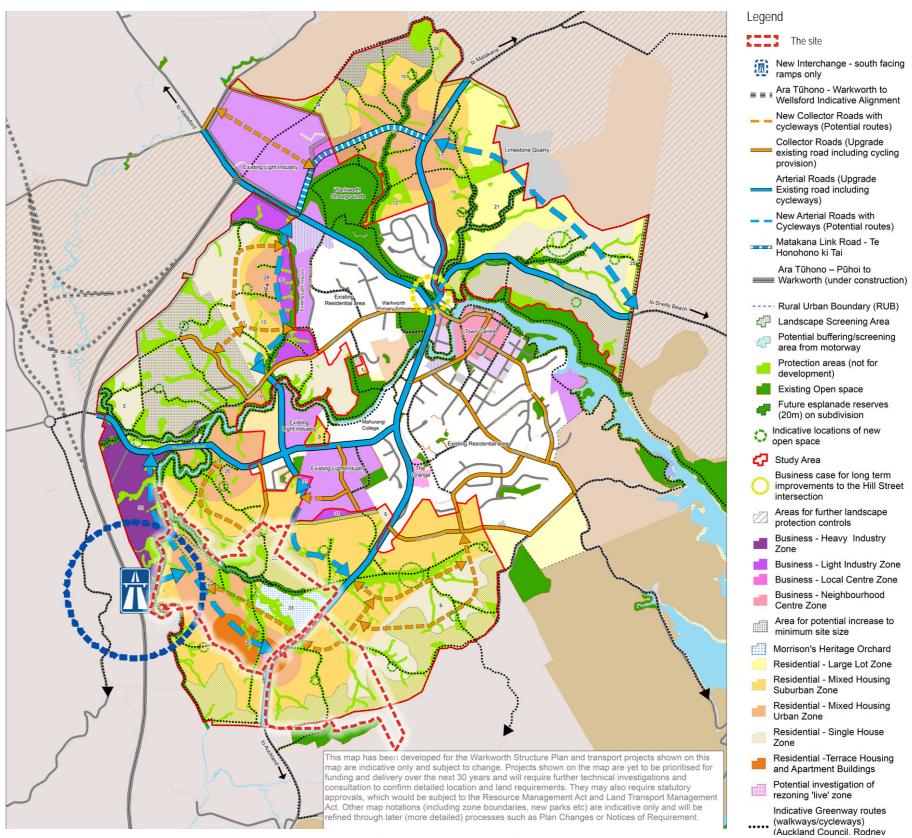


Figure 8 - Warkworth Structure Plan- Land use plan with PPC extent overlaid (Source: Warkworth Structure Plan)

3. SITE ANALYSIS

3.1 Site Location

The Masterplan Site is located near the southern end of Warkworth which is approximately 50km north of central Auckland. The site sits 3km from the Warkworth Town Centre and has convenient access to the existing State Highway 1 that is immediately adjacent.

The Warkworth town centre has been historically formed around the Mahurangi River which creates a unique natural and built form character of Warkworth.

The western site is currently accessed off Valerie Close from the existing State Highway 1 while the eastern site has direct access from SH1 through two separate driveways. Valerie Close together with Avice Miller Reserve defines the southern boundary of the site. A branch of Mahurangi River borders the site to the west with numerous minor tributaries across the entire site. The northernmost part of the site provides for a physical link to the existing urban fabric in the vicinity of Mason Heights.

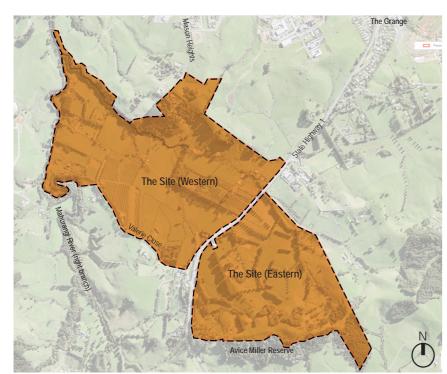


Figure 10 - Site Boundary

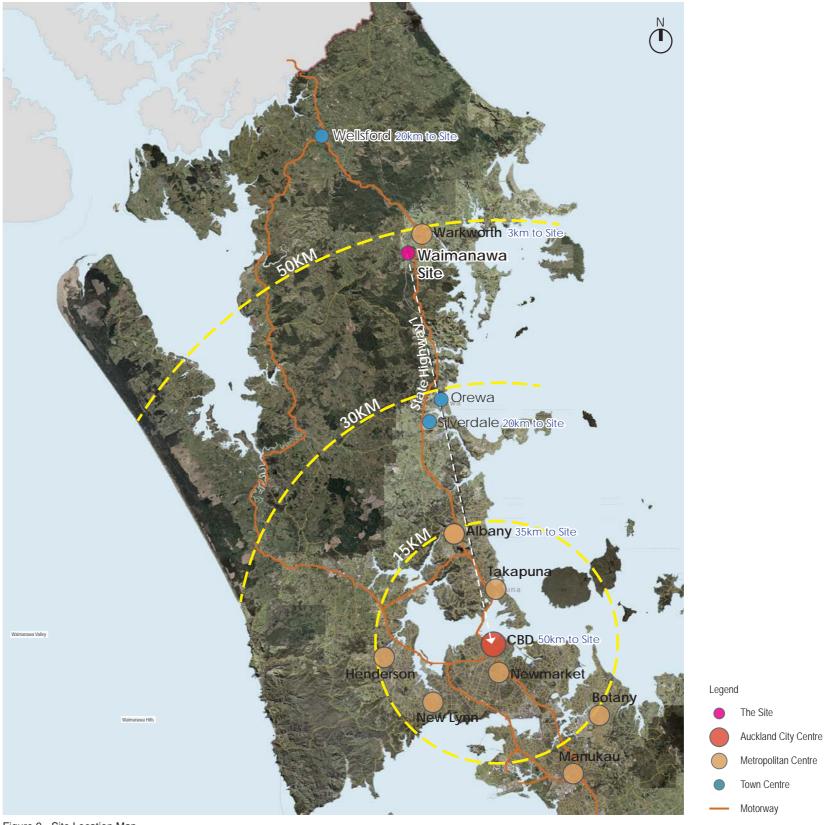


Figure 9 - Site Location Map

3.2 Wider Context

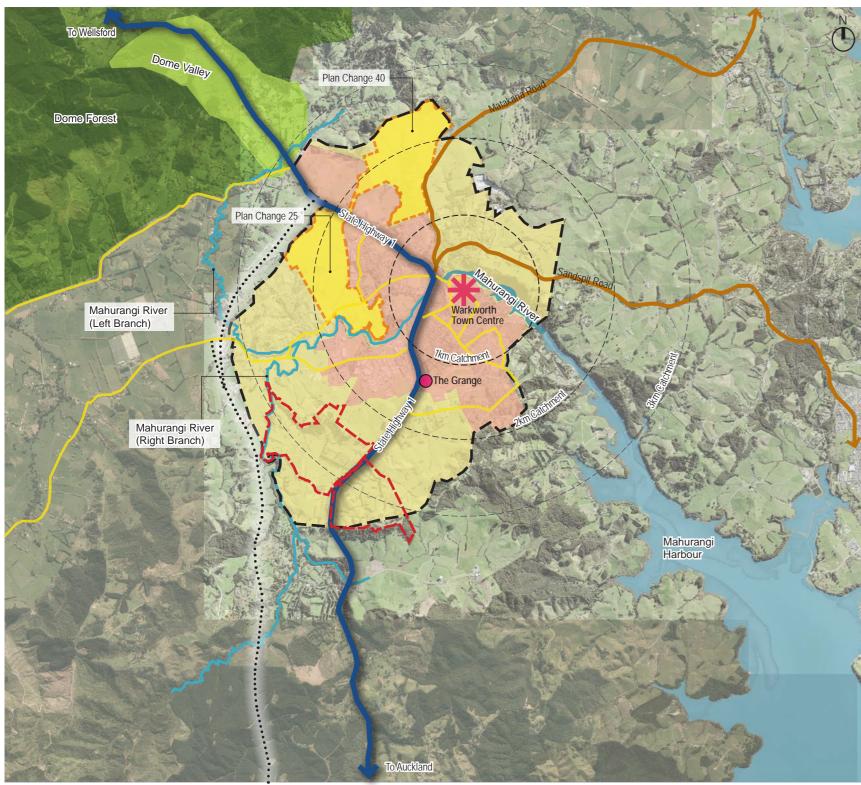


Figure 11 - Warkworth Context Plan

Currently, Warkworth is the largest rural town within the northern Auckland region, providing a wide range of services and employment opportunities to the surrounding small towns, rural hinterland and coastal areas. Warkworth also acts as a gateway to a number of small towns, particular to the east to the coastal settlements and tourist destinations such as Matakana, Snells Beach, Leigh and Omaha.

The Warkworth Town Centre sits on the edge of Mahurangi River estuary where it meets the northern reaches of Mahurangi Harbour. State Highway1 traverses through Warkworth in a north-south direction and heads westwards to Dome Valley. The current urban area including the Town Centre is concentrated around the Mahurangi River and the State Highway corridor.

Around 1,000 ha of currently rural land immediately surrounding Warkworth has been zoned Future Urban in the AUP. In particular, Warkworth South contains the largest area of Future Urban land due to its flat land, planned local centre, a public transport hub and the future connection to Ara Tūhono – Pūhoi to Warkworth. Comprising around 493 ha of land, Warkworth South will accommodate approximately 3,700 additional dwellings in the future.



3.3 Warkworth Context

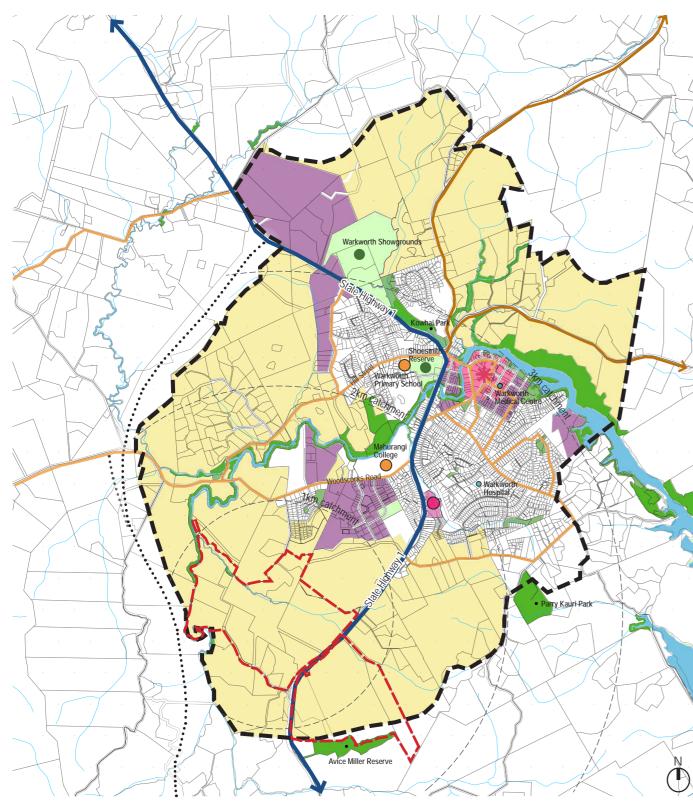


Figure 12 - Local Context Plan

The site sits strategically on a generally low to gentle-contoured valley within the wider Future Urban area in South Warkworth, with the surrounding area currently dominated by pastoral and rural lifestyle activities.

Within the existing urban footprint, residential uses are predominant around the town centre and along the SH1 corridor. In terms of built form, low density 1-2 storey detached residential dwellings are laid out relatively evenly amongst a mixture of basins and stream valleys. Pockets of light industrial land are present in the outskirts of the existing urban areas. The light industrial area along Woodcocks Road 1.5km north of the site provides both industrial uses and large format retail.

A series of esplanade reserves and riparian margins are provided along the main branches of Mahurangi River and some of its tributaries. The nearest conservation reserve is the Avice Miller Reserve located beyond the Rural Urban Boundary to the east of SH1. Within the entire Warkworth, majority of the open spaces are associated with esplanade, native bush reserves, sports fields and community green infrastructure. However, Warkworth is lack of park or open spaces for recreational purposes.

Mahurangi College is located 1.5km north of the site on Woodcocks Road and Warkworth Primary School is 2.5km to the north on Hill Street. As noted in the WSP, two further primary schools and a secondary school are liked to be required in the medium to long term, however, the location of these schools are still under investigation by the Ministry of Education.

The Kowhai Surgery and the Warkworth Medical Centre are located in Town Centre providing general practitioner services for Warkworth. The privately funded Rodney Surgical Centre is located 1km north of the site.



3.4 Surrounding Context

Uses

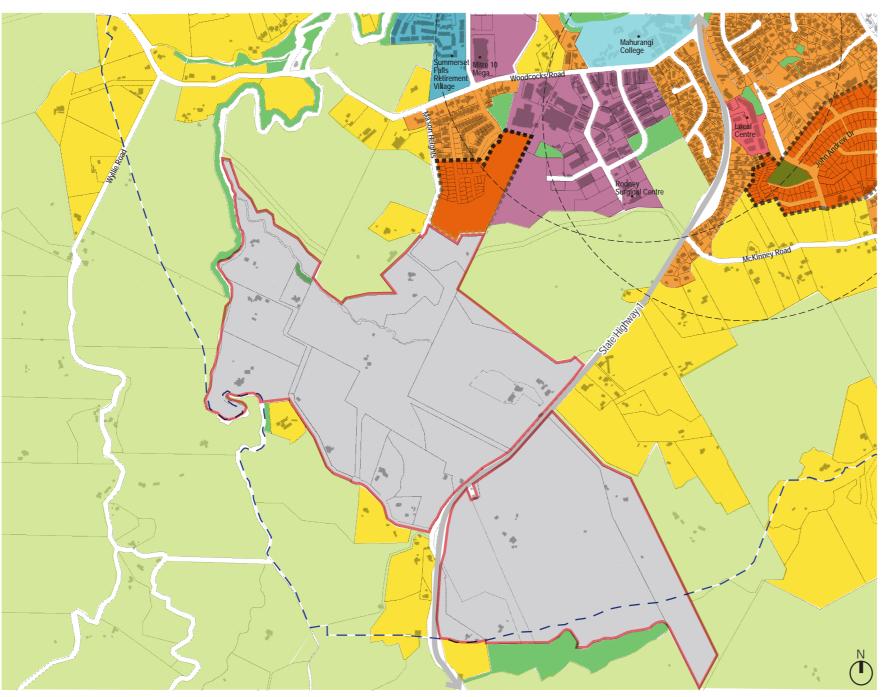


Figure 13 - Warkworth South Context - Uses

The Future Urban land within Warkworth South comprises a broad area of 493 ha of land with predominantly pastoral and rural lifestyle activities. The northern section of Warkworth South area has a strong connection with the adjoining urban activities as a number of recently built residential developments are emerging towards the fringe of urban areas and growing into the Future Urban land (Refer to diagram to the left).



Movement Network

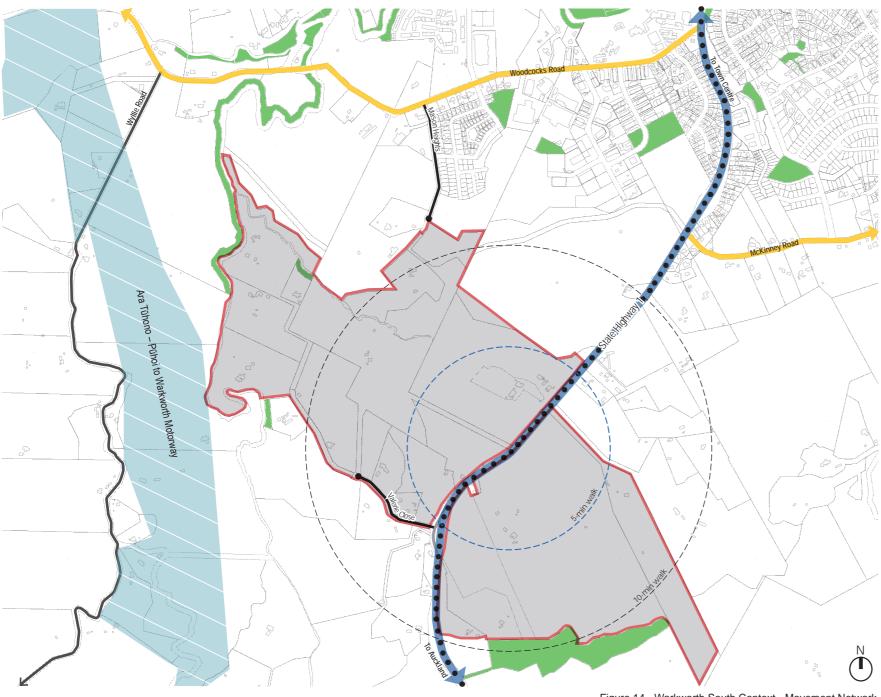


Figure 14 - Warkworth South Context - Movement Network

As with the bulk of the town, Warkworth South is currently split by the existing SH1 travelling north south. SH1 provides primary access to the sites alongside the motorway. Woodcocks Road is a main collector road accessed off SH1which provides access to the existing urban areas and the future urban land to the west of SH1 in Warkworth South. The site can be accessed from the north through Mason Heights, a local road linked to Woodcocks Road.

The new Ara Tūhono – Pūhoi to Warkworth Motorway is currently under construction which traverses on the periphery of the Warkworth future urban area to the west. The new motorway is expected to open in late 2022 at which time the current State Highway 1 will become an arterial road under the control of Auckland Transport.



Natural Environment


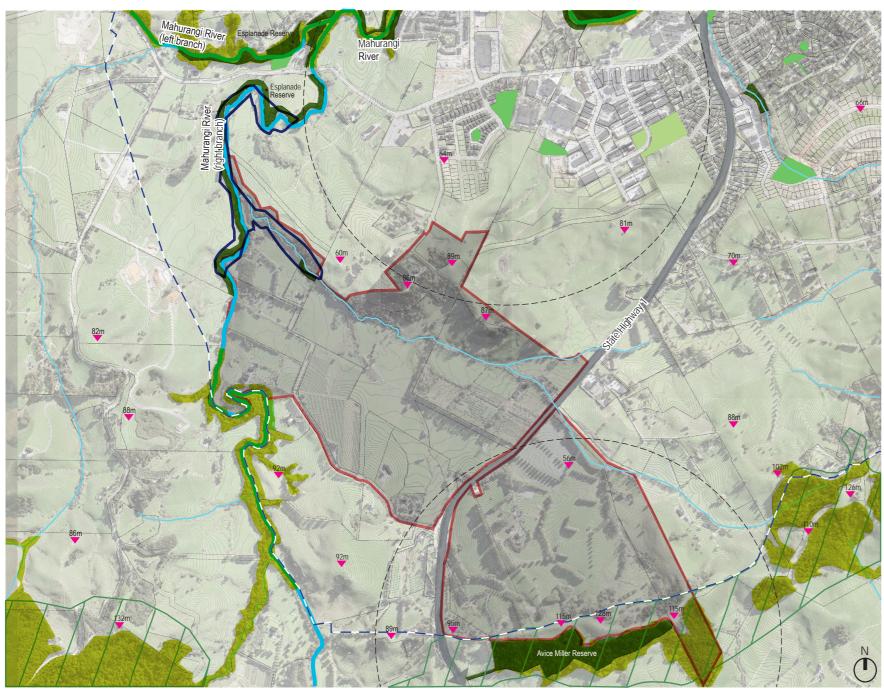


Figure 15 - Warkworth South Context - Natural Environment

In terms of natural land form, the Warkworth South area is broadly framed by a series of elevated ridges and hill slopes to the south which define the outer edges of the future urban area within the Warkworth 'basin'. Within this catchment basin, a mixture of major streams, tributaries and more localised watercourse form a series of stream valleys and flood plains which are intermixed with a rolling matrix of spurs and hill slopes.

Avice Miller Scenic Reserve defines the southern boundary of the eastern site which is covered by predominantly indigenous species including podocarp trees, kauri, rimu, tōtara and kahikatea. These forest remnants extend further eastwards to the Thompson Road ridge, all of which are identified as Significant Ecological Areas under the AUP and form a large ONL wrapping along the ridges framing the future urban land in Warkworth South. SEA are also located along the right arm of the Mahurangi River from the southwestern corner of the site towards a major stand of bush to the south.

Currently, there are few public recreational reserves provided in Warkworth South and those that are function as stormwater attenuation and lack local/community parks for active recreational activities. A number of reserves for stormwater purposes to the south of Woodcocks Road are within 10-min walking distance from the northern end of the site.

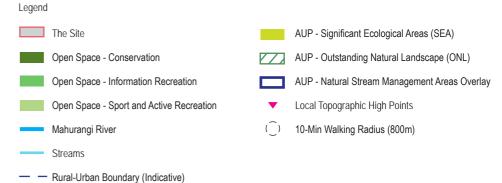


4. MASTERPLAN VISION

4.1 Vision

Creating a welcoming residential community with a range of engaging facilities set upon a series of parks along the southern reaches of the Mahurangi River.



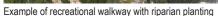



Example of suburban residential frontage



Example of Local Centre



Example of stormwater park

4.2 Overarching Goals



vegetation and ecological corridors.












5. URBAN DESIGN STRUCTURE

5.1 Design Principles

To achieve the overarching vision and the goals, a set of high-level design principles and key design strategies has been developed to provide a meaning guide for the masterplan layout.



Enhance the existing ecosystem and natural landscape features

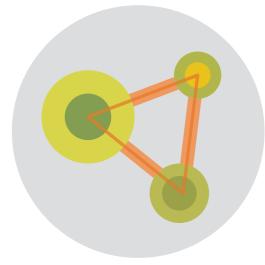

Create a high quality public realm that is connected and accessible to all



Create a healthy and sustainable community for people of all ages



Provide for a legible network of roads, local streets, lanes and walking and cycling routes



Promote efficient use of land




Celebrate the unique identity of Warkworth South and create a sense of place

5.2 Design Strategies


On the basis of the high-level principles, a series of site-responsive design strategies are developed to help establish a welcoming residential community with a high level of connectivity and quality amenity spaces.

Ecology

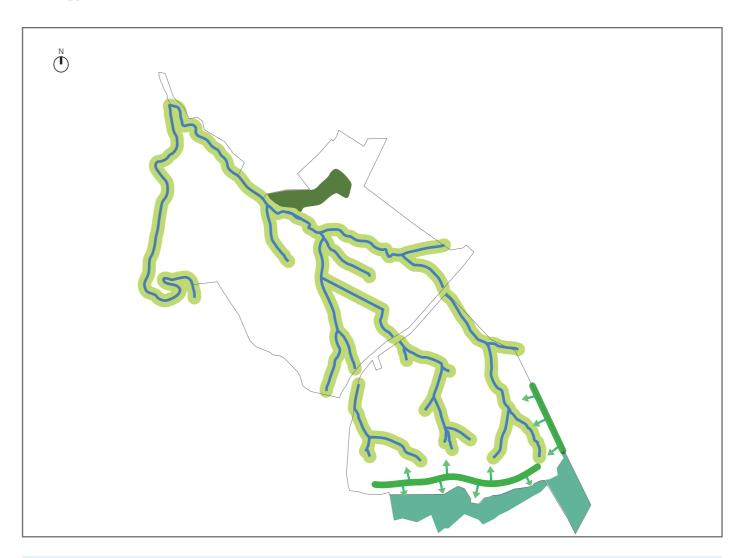


- Protect the existing natural watercourses and enhance ecological corridors
- Maintain and enhance significant indigenous forests and natural wetlands
- Protect the landscape character of Avice Miller Scenic Reserve and escarpments

Transport

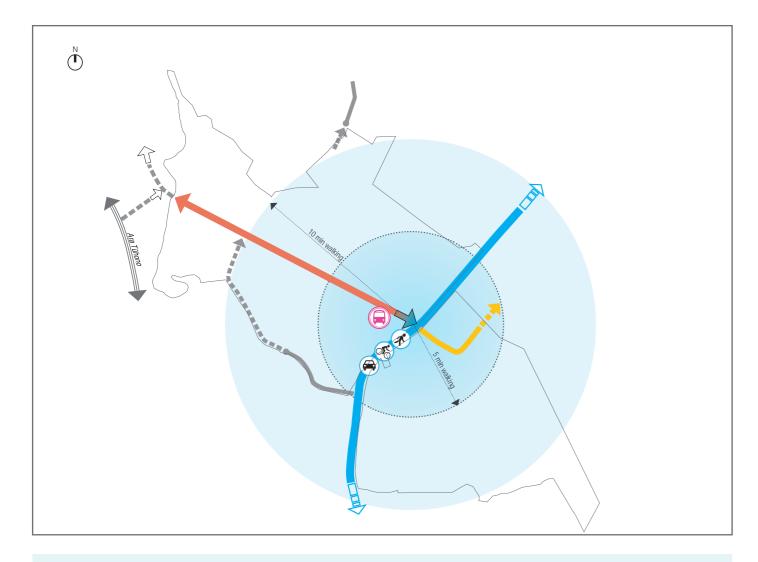


- Connect to the existing motorway and enhance the arterial connection to the Warkworth town centre
- Create a direct and efficient indicative route for Wider Western Link Road across the areas with gentle contours
- Locate future public transport interchange near the key intersection of urban arterial roads (SH1 & WWLR)

Urban Form

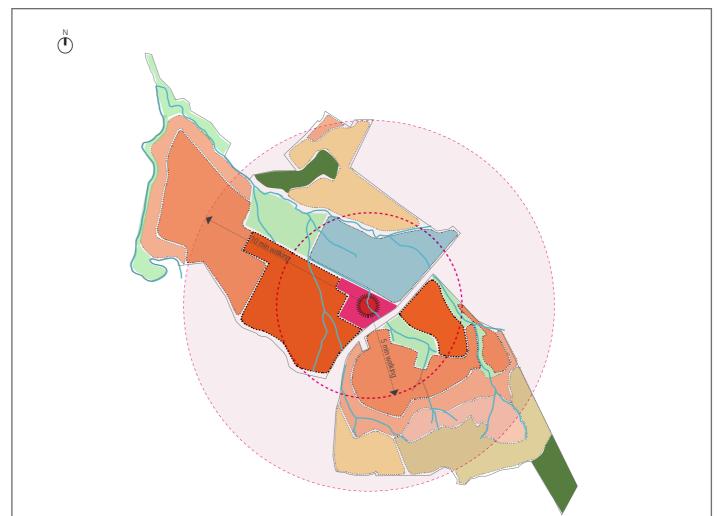


- Place a local centre that serves a wide catchment in south Warkworth area
- Fit in a sympathetic urban form following natural contours and provide for suitable residential uses and density transitions
- Locate higher density residential around the local centre and key transport corridors
- Provide reduced urban density transitions along the main stream corridors and local ridges at the perimeter of the site

Open Space

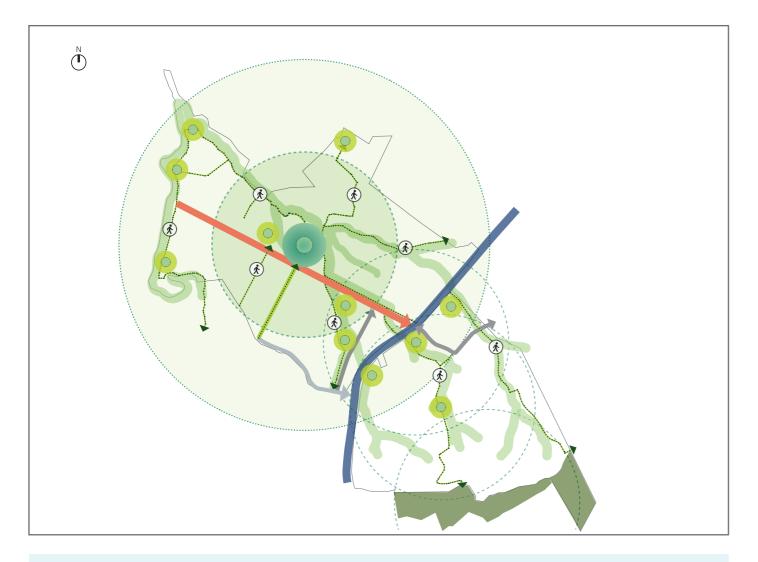

- Create a generously-sized suburb park as a key open space for the entire community
- Establish a series of open spaces along the stream corridors to provide both amenity and infrastructure
- Provide green links for pedestrians and cyclists across the site and to wider areas

Identity

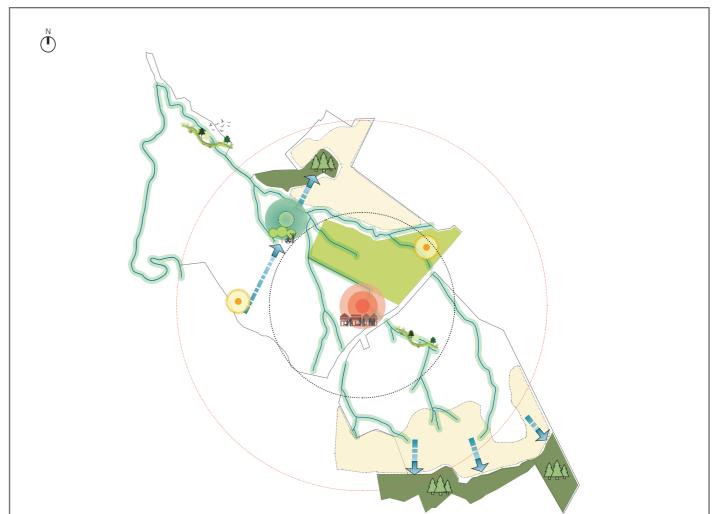

- Morrison Heritage Orchard retains its rural character contributing to the local identity
- Enhance the ecological values along the natural streams through riparian planting
- Provide key physical and visual connections to the patches of indigenous forest and promote native re-vegetation across the local ridges adjacent to Avice Miller Scenic Reserve to strengthen the landscape character in Warkworth south

5.3 Zoning Concept Plan


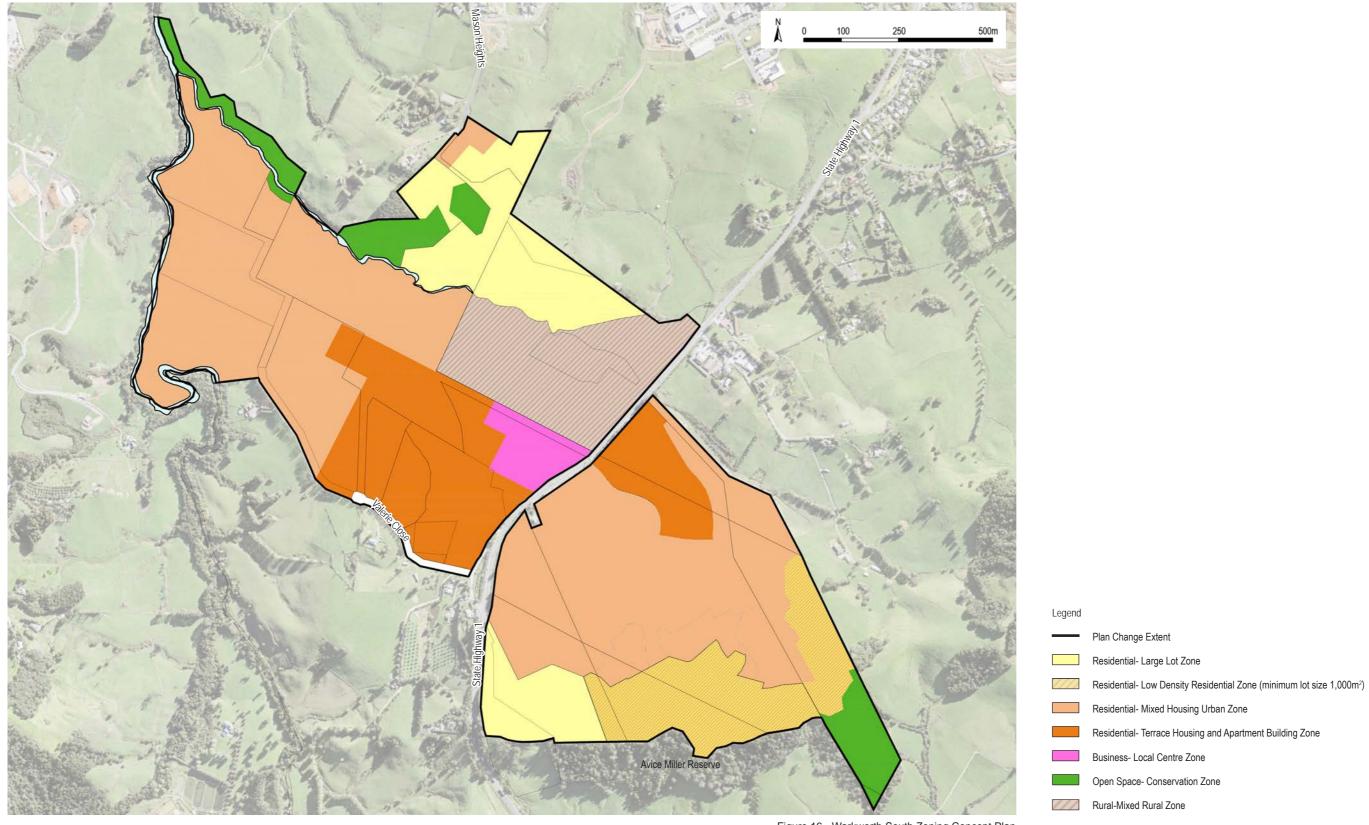


Figure 16 - Warkworth South Zoning Concept Plan

5.4 Indicative Masterplan

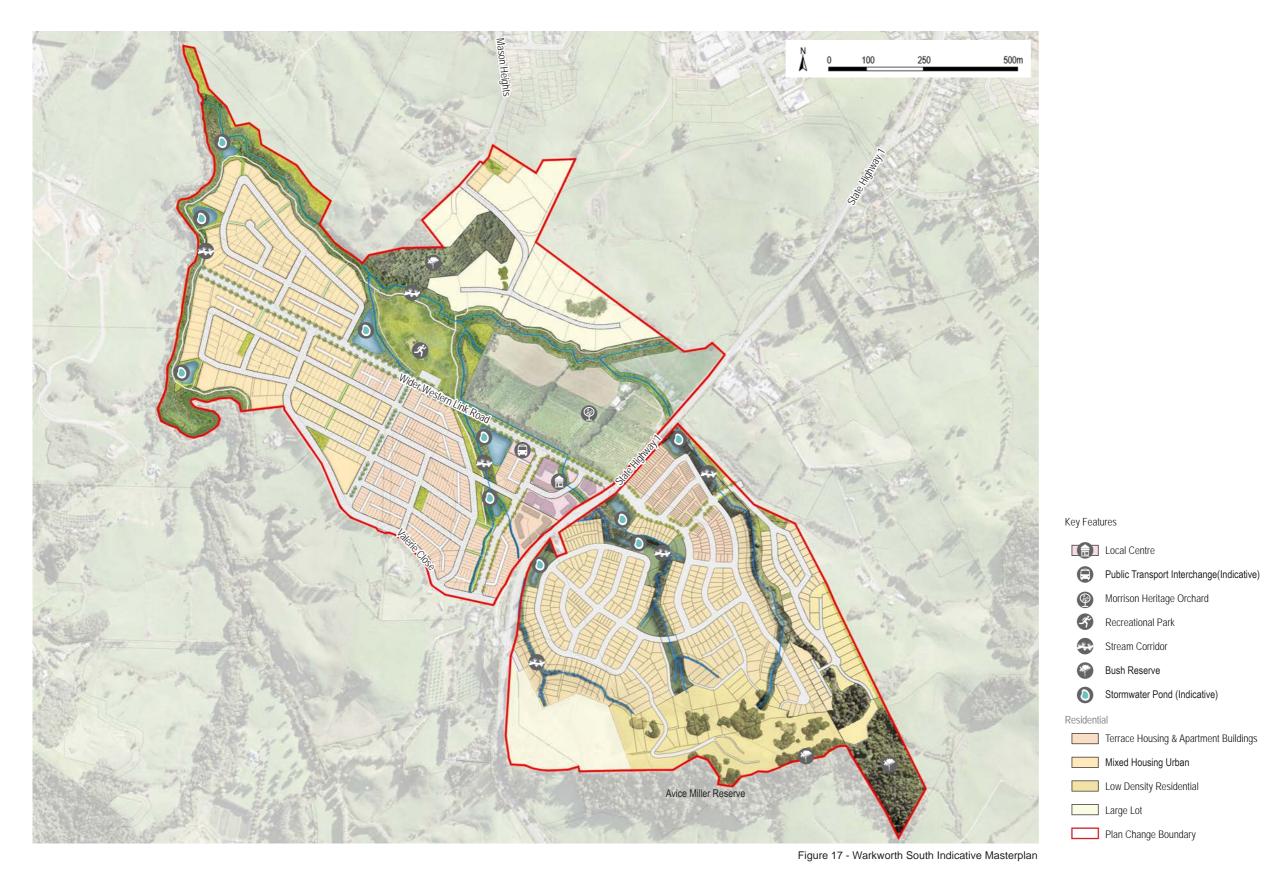

5.4 Residential Yield

The proposed masterplan identifies a logical land use pattern which supports efficiency, appropriate balance of land use distribution and diversity of residential opportunities. The key land use and yield metrics identified by the indicative masterplan are outlined in the chart below.

The proposed masterplan will provide approximately 1433 residential lots and 173 apartment units with 82% of the site area being zoned residential. The location and extent of THAB zones respond to the natural topography and the walkable catchment relative to the local centre and public transport hub. Mixed Housing Urban zones are predominantly provided across the gentle valley floor and the lower slopes in the east. Low Density Residential zoned land with spatial control is provided across the eastern escarpment and the local ridgeline in the northeast to minimise the impacts on the immediate and wider landscape. Large lot areas are located in the vicinity of the northern escarpment to help enhance a portion of Warkworth's rural character which is largely retained within the Morrison Heritage Orchard. To the east, the southwestern corner of Waimanawa Hills site will provide for large lot development to respond to the limited access from SH1 and provide further protection to Avice Miller Scenic Reserve and Outstanding Natural Landscape to the south.

		Waimanawa Valley (Land West of SH1)			Waimanawa Hills (Land East of SH1)			Entire Plan Change Site			
Zoning		Land Area (Hectare)	Percentage of Total Site Area	Residential Yield	Land Area (Hectare)	Percentage of Total Site Area	Residential Yield	Land Area (Hectare)	Percentage of Total Site Area	Residential Yield	Indicative Open Space Provisions (Hectare)
	Terrace housing and Apartment Buildings	19.600	11.88%	367 lots + 105 Apartments	5.778	3.50%	183 lots	25.378	15.38%	550 lots + 105 Apartments	1.171
	Mixed Housing Urban	38.393	23.27%	352 lots	35.847	21.73%	455 lots	74.240	45.00%	807 lots	15.093
Residential	Low Density Residential	0.000	0.00%	-	14.476	22.10%	41 lots	14.476	8.77%	41 lots	0
	Large Lot	14.654	8.88%	23 lots	6.015	9.18%	12 lots	20.669	12.53%	35 lots	0
	Sub-total	72.647	44.03%	742 lots + 105 Apartments	62.116	37.65%	691 lots	134.763	81.68%	1433 lots + 105 Apartments	16.264
Business	Local Centre	3.415	2.07%	68 Apartments	0.000	0.00%	-	3.415	2.07%	68 Apartments	0
business	Sub-total	3.415	2.07%	68 Apartments	0.000	0.00%	-	3.415	2.07%	68 Apartments	0
Open Space	Open Space - Conservation	5.718	3.47%	-	3.378	2.05%	-	9.096	5.51%	-	9.096
Орен Зрасе	Sub-total	5.718	3.47%	-	3.378	2.05%	-	9.096	5.51%	-	9.096
Rural	Rural-Mixed Rural	15.233	9.23%	-	0.000	0.00%	-	15.233	9.23%	-	0
Kurai	Sub-total	15.233	9.23%	-	0.000	0.00%	-	15.233	9.23%	-	0
	Others (Existing road/streams/ watercourses/possible landtake)	2.480	1.50%	-	0.000	0.00%	-	2.480	1.50%	-	0
	Total	99.49	60.31%	742 lots + 173 Apartments	65.49	39.70%	691 lots	164.98	100.00%	1433 lots + 173 Apartments	25.36

Figure 18 - Warkworth South Land Use Metrics & Yield Chart

5.5 Open Space Provisions



Figure 19 - Indicative Location & Extent of Key Open Spaces

Open spaces are generously provided within the Plan Change area and primarily include the following:

- A large suburb park functions as a key open space providing a range of recreational activities for the entire community
- A series of smaller open spaces including neighbourhood and pocket parks are provided along the stream corridors
- Existing bush reserves and covenanted areas will be retained
- All protected streams will be enhanced by various provisions of riparian yard

The indicative open spaces identified in the proposed masterplan align with the Green Network Plan of Warkworth Structure Plan (WSP) for the following reasons:

- The large open space shown in the WSP is enabled by the proposed suburb park with a proximate location
- 20m Riparian yards are provided in alignment with the 'future esplanade reserve(20m) on subdivision' identified in the WSP
- The proposed masterplan indicates more open spaces on both western and eastern sites than that is proposed by the WSP.

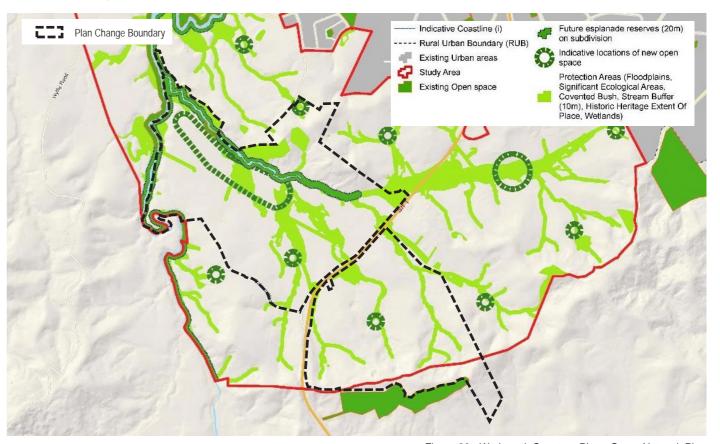


Figure 20 - Warkworth Structure Plan - Green Network Plan


5.6 Street Network



Figure 21 - Indicative Street Network


The street network will provide a legible pattern for all users within the Plan Change area, including

- Create the Wider Western Link Road in the most direct and efficient way that links SH1 with the southwestern growth area and the Southern Interchange
- The proposed intersection of SH1 and WWLR will enable key vehicular, pedestrian and cyclist access to both Waimanawa Valley and Waimanawa Hills
- The proposed green avenue and the road between WWLR and Valerie Close through the new local centre will provide good north-south connectivity from/onto the arterial routes within the Waimanawa Valley and these streets will be constructed to collector road standards
- The proposed collector road within Waimanawa Hills enables key access from SH1 and provides a linkage to the future developments north of the site
- A safe crossing point for pedestrians and cyclists between the western and eastern sites is proposed at the intersection of SH1 & WWLR
- The arrangement of load roads considers the natural topography and supports functional connectivity and efficient land-use
- · Separate cycle lanes will be provided along WWLR, the green avenue and new collector road
- Pedestrian paths are essentially provided within the street network
- Off-road recreational pedestrian and cycling links are broadly provided throughout the site with good connectivity to reserves, parks and open spaces associated with the stream corridors
- Park edge roads are provided in practical locations where the adjoining stream edges are not subject to Bat Flight Corridor/ sections of multiple small ownerships and result in improved public amenity than those open spaces(riparian yards) suitably integrated into subdivision
- Roading connections constructed to local road standards through the developments across northern and eastern escarpment areas are limited so as to achieve roading efficiency and practical gradients and avoid creating high retaining walls on either side of the road

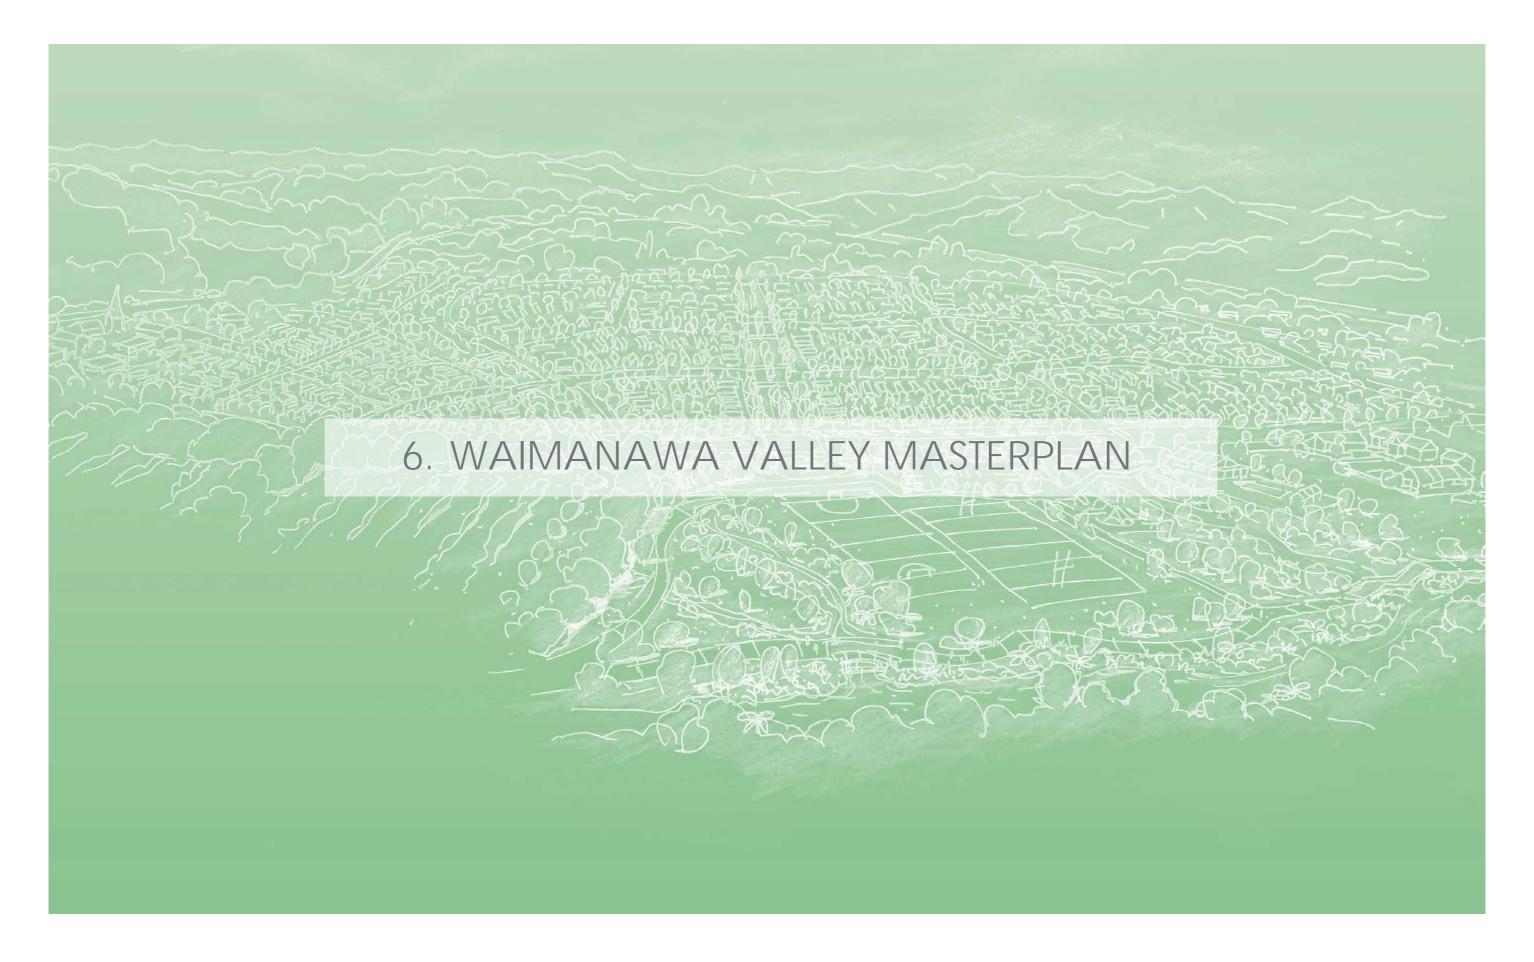


6.1 Existing Site Features

Topography and Landform

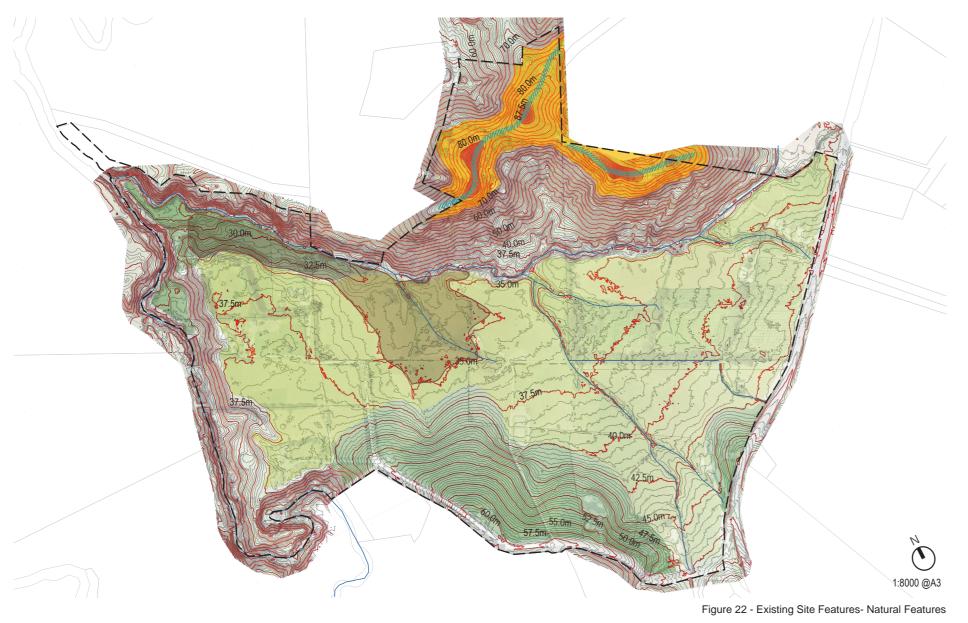



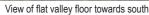



View from southeastern corner towards northern escarpments



View of gently sloped land towards Valerie Close

The site is topographically characterised by a gently-contoured valley in the south and a primary ridgeline with several spurs extending along the northernmost portion of the site. The ridge in the north runs in a southwest-northeast direction and ascends to a high point of 87.5m near the northeast corner. Extended off the ridge to the east, is a spur running toward the SH1 which defines the eastern part of the northern boundary. The ridgeline together with the associated spurs visually contains the site from the north.

Within the valley floor, the site generally falls towards the north and west from Valerie Close and SH1. Extending centrally from Valerie Close is a gentle slope with 20m fall (approx.) that forms an elevated feature along the southern boundary.

The land adjacent to the western boundary has a more undulated contour as it intermixes with riparian margins of Mahurangi River.

Legend

Major Contour (2.5m)

— Intermediate Contour (0.5m)

Ridge

Area above RL 70.0m

Hill Top

Flat Area (slope < 1 in 20)

Easy-Contour Area (slope between 1 in 20 to 1 in 9.5)

Alluvial Lowlands

Natural Features





Mahurangi River



Kanuka Forest





The right arm of the Mahurangi River runs in a north-south direction along the site's western boundary. A primary tributary of this river extends across the site in the middle following a west-east direction which provides a physical separation between the stream valley and the northern hill feature. Within the eastern portion of the site, a number of minor tributaries collect the complex drainage patterns falling from the south and the east as well as those further beyond the site on the other side of Valerie Close and SH1. These minor tributaries cut through the stream valley in a incised manner. A short watercourse exists in the central area of the site where it drains a pocket of constructed wetland.

The southwestern corner of the site features a corridor of indigenous vegetation consisting predominantly of mature native trees including kānuka (Kunzea ericoides) and pōhutukawa (Metrosideros excelsa). Along the north-western and northern boundaries of the site following the streams, the riparian margin is dominated by kānuka forest which extends uphill to cover 3.3ha(approx.) of land. A smaller stand of mature vegetation sits 150m east of the extensive kānuka forest and features a mixture of native podocarp and broadleaved trees, some of which are in poor health condition. A small patch of natural wetland exists at the base of a gully between the ridges and is dominated by mercer grass.



Built Environment



The site's built environment is characterised by rural residential and pastoral grazing activities. Residential dwellings are dispersed along the existing SH1, Valerie Close and streams corridors to the west. Complemented by a series of concrete/gravel lanes, Valerie Close provides primary access to the properties in the southern part of the site. The previous Ransom Winery buildings sits on a relatively high point west to the end of Valerie Close.

A number of temporary workers accommodation sheds are located adjacent to SH1 and the former Ransom Winery building.

Access to the Morrison's Heritage Orchard is via SH1. The properties in the northern portion of the site are accessed off Mason Heights.

Overall, the site's built environment has an unremarkable pattern featuring scattered residential dwellings, farm buildings and temporary structures connected by loose roading network, which is a reflection of the typical hinterland of rural settlements within the Auckland region.



State Highway 1









6.2 Site Constraints & Opportunities

Watercourses & Landforms

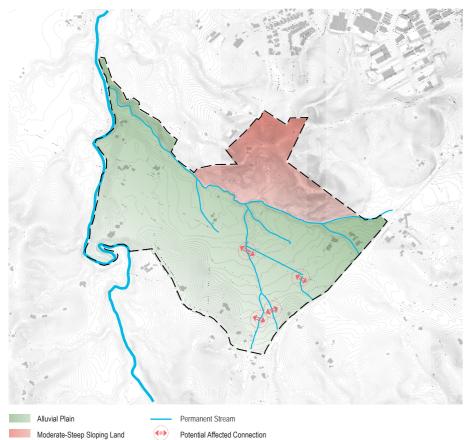

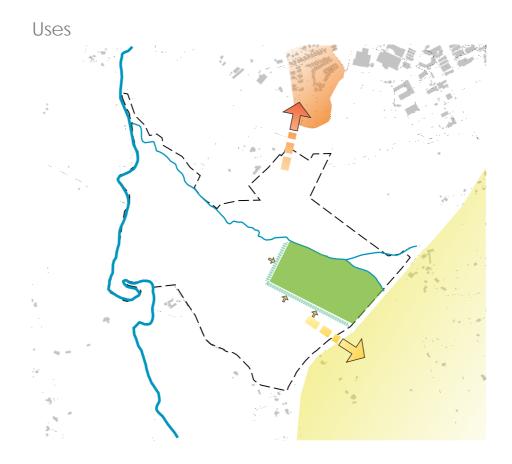

The site lies to the south of a main tributary of the Mahurangi River and is largely flat with gentle slopes towards Valerie Close which makes this area well suited for medium to high density development.

Potential Affected Connection

- A number of minor tributaries that run through the alluvial plain in the southeastern part of the site may require additional engineering in terms of providing continuous road connections.
- The steeply-contoured bush clad in the northern part of the site is less suitable for intensive urban subdivision and provides a visual break to the developments in the south.
- The northern area of the site's proximity to the most recent subdivision development on Mason Heights suggests a logical connection to the existing urban fabric in Warkworth.
- The site's strategic location and direct access from motorway indicate its strong ability to provide local services, various urban uses and open spaces to a wide catchment in Warkworth South
- Morrison's Heritage Orchard and its potential complementary activities enables the opportunity to act as a key destination in Warkworth South whilst continuing to contribute to the local rural character.

Open Spaces & Ecology

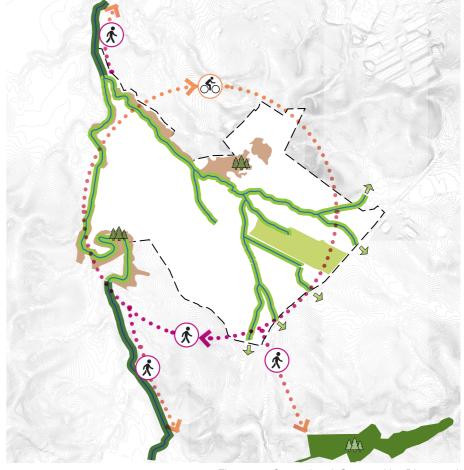
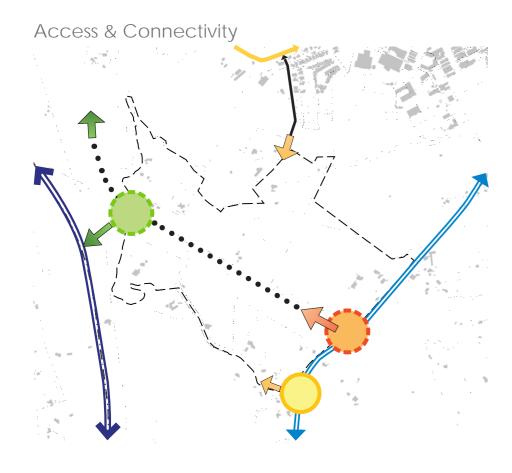
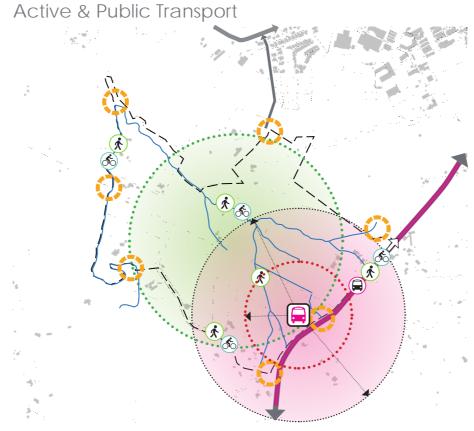


Figure 25 - Constraints & Opportunities Diagrams A

- The right arm of the Mahurangi River and its tributaries offer opportunity for natural amenity and highly-connected open spaces which form an integral part of the ecological system in Warkworth South
- The existing Kānuka forest along the north-western boundary of the site presents a natural landscape feature on the hill slopes which contributes to the broader landscape in Warkworth





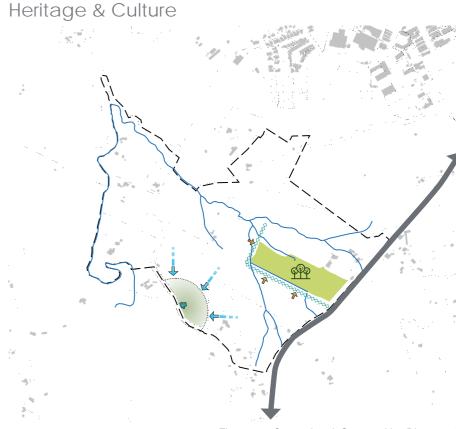


Figure 26 - Constraints & Opportunities Diagrams B

- The site is in close proximity to the existing SH1along its eastern boundary
- With future connections from its western boundary, the site has convenient access to the new motorway and the proposed Wider Western Link Road
- Currently, Valerie Close and Mason Heights provide direct access to the site from SH1 and Woodcocks road respectively which offers easy access to the Warkworth town centre and the employment area in the vicinity of Woodcocks Road
- The proposed Wider Western Link Road that traverses through the site is an urban arterial road with limited access points from both sides of this route

- The proposed public transport interchange within the site supports a
 walkable neighbourhood and caters for an extensive walking and cycling
 network.
- The riparian margins of the permanent streams offer opportunity for offroad pedestrian and cyclist routes.
- The site contains no archaeological site of significance or other historic heritage sites that may raise constraints to the proposed urban developments.
- Morrison's Heritage Orchard will continue acting as a destination with rural characters that reinforces the historic and cultural values within the site.
- The existing Ransom Winery building sits on an elevated location that
 overlooks the flat alluvial plain and the northern slopes. There is an
 opportunity to create enhanced visual and physical connections to these
 site features.

6.3 Key Moves


On the basis of the high-level principles, a series of specific and site-responsive moves are developed to help establish a welcoming residential community with good connections and quality amenity spaces.

The key moves are:

- Maintain and enhance the existing streams, forests and wetlands
- Connect to the larger arterial network
- Fit a sympathetic urban form onto the site
- Provide generous open spaces and infrastructure as the focus for the development
- Provide a local centre as a key destination for wider area in Warkworth South
- Maintain and enhance the landscape, historical and cultural values
- Provide for a dynamic mix of activities, densities and housing options


Move 1

Maintain and enhance the existing streams, forests and wetlands

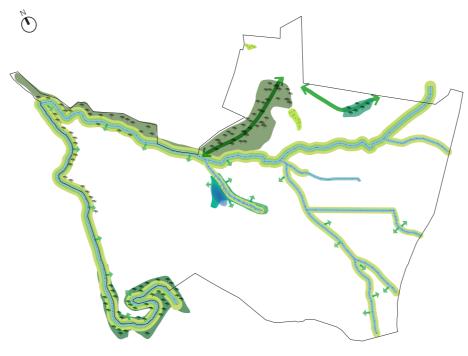

Connect to the larger arterial network

Move 2

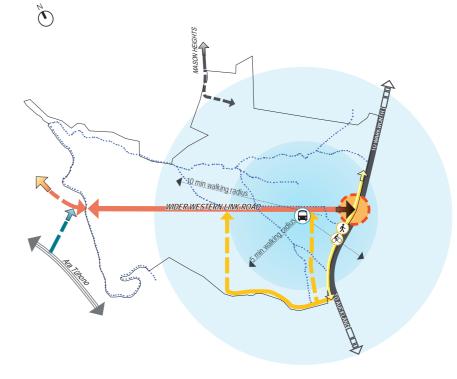

- Maintain all permanent streams and natural wetland
- Protect and enhance bush reserves along the ridges to the north
- Protect and restore the existing indigenous riparian vegetation within the south-western corner of the site
- Leverage the existing constructed wetland to integrate with stormwater management facilities
- · Set development back from the natural interfaces of

- Create the Wider Western Link Road in a most direct way which links SH1 with the south-western growth area and the Southern Interchange
- Locate the public transport interchange on the Wider Western Link road adjacent to SH1
- Provide the pedestrian and cycle linkage along SH1
- Provide key north-south connections between WWLR and Valerie Close
- Provide a key crossing for pedestrian and cyclist between the western and eastern sites at the intersection of SH1 & WWLR


Move 3



Fit a sympathetic urban form onto the site

- Create street and subdivision patterns in a compact manner that fit comfortably with the existing contours
- Locate a mixed-use local centre along the Wider Western Link Road with good access to SH1 and the proposed Ara Tūhono
- Encourage greater housing density within the 5-min walk catchment of the proposed local centre and major park


Move 4 Provide generous open spaces and infrastructure as the focus for the development

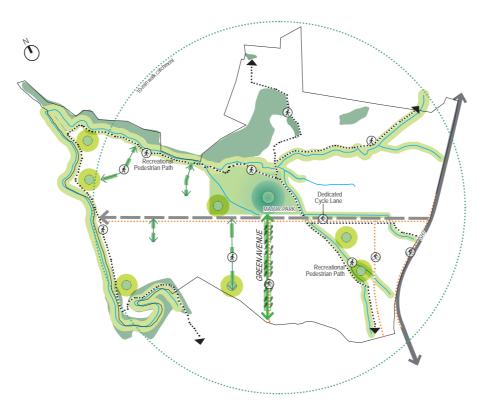

- Provide a generously-sized community park at a strategic location
- Create a linear series of parks alongside valley floor, the river and forest
- Link all reserves, parks and wetlands with recreational paths
- Provide pedestrian and cycle links across the entire site
- Integrate stormwater management areas with open spaces to provide for additional on-site amenity

Move 5


Provide a local centre as a key destination for wider area in Warkworth South

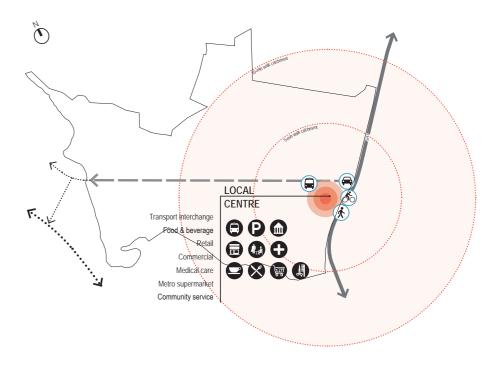

- Provide for a local centre with presence and which supports a range of activities to meet the needs of local and broader community
- Integrate public transport interchange with the local centre
- Provide easy access to the local centre from the immediate neighbourhood, Warkworth Town Centre, wider Warkworth area and the planned transport corridor via various transport modes

Move 6

Maintain and enhance the landscape, historical and cultural values

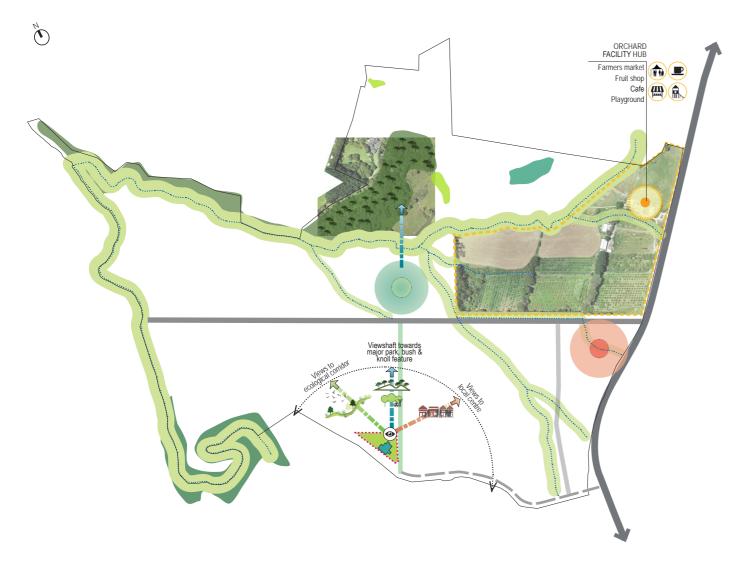

- Retain the Morrison's Heritage Orchard as a rural feature for Warkworth and enable additional complementary activities
- Orientate localised street views towards the remnant bush along the northern slopes

Move 7

<u>Provide for a dynamic mix of activities, densities and housing options</u>



- Provide for the greatest residential density in close proximity to both local centre and transport interchange
- Create a dynamic mix of urban residential developments on the gently terraced slopes
- Provide reduced density of residential developments towards key stream corridors on the periphery
- Locate the low density large lot development over the local knoll feature in the north



The masterplan on the left demonstrates an indicative layout of the future development of the Waimanawa site. The illustrative plan sets out the urban design framework for the site which is intended to guide the subsequent subdivision development. The key urban design considerations that the masterplan highlights are:

- Locate an appropriately-sized local centre at the intersection of the existing SH1 and the proposed Wider Western Link Road
- Enable increased residential density around the local centre, the proposed public interchange and adjacent to the major park
- Enhance the Mahurangi River and its tributaries with a series of linear open spaces as a core structural element of the development
- Create a large park centrally-positioned within the site providing for sports fields and informal recreational activities
- Establish a clear visual corridor from Valerie Close to the central park to maintain the views towards the landscape on the northern slopes
- Provide a legible and efficient roading network with a clear hierarchy of arterial roads, secondary links, local accessway and private lanes
- Enable continuous walking and cycling links both within the road reserves and "off-road" alongside the riparian margins and through mid-blocks
- Propose lower density residential development with large section sizes over the knoll and elevated hills within the northern portion of the site
- Protect the existing pūriri and kānuka forests and ensure weed management and additional infill vegetation



Example of residential development



Example of mixed use local centre



Example of riparian margin

6.5 Land Uses


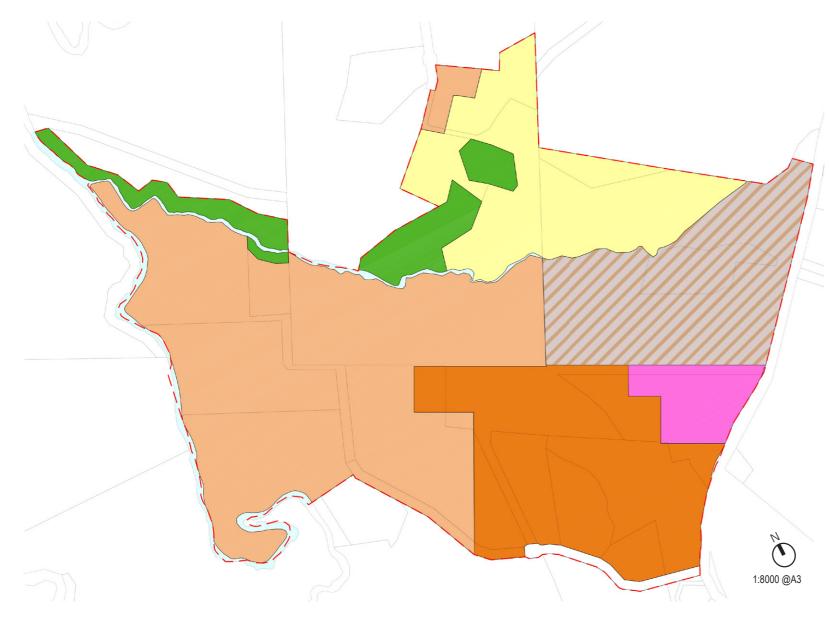


Figure 28 - Zoning Plan

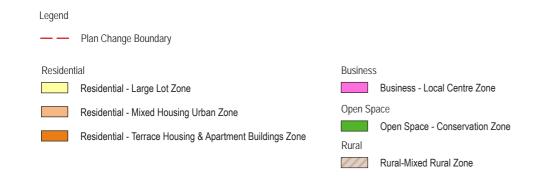

Building on the site's opportunities and constraints and the key design considerations, the configuration of the land use aims to optimise opportunities for high quality urban residential, create extensive open spaces, aid maintenance of landscape features and ecological values.

The proposed land uses respond to the land use plan set out in the Warkworth Structure Plan which provides for predominantly residential uses, a local centre and a series of open spaces associated with natural streams and local landscape features.

The Local Centre zone is located immediately adjoining the SH1 and the Wider Western Link Road to ensure that the new centre serves a wider catchment area within Warkworth South.

The area in close proximity to the local centre provides for the greatest residential density- Terrace Housing and Apartment Zone. This high density residential area aims to efficiently utilise the land that has convenient access to local services, retail, public transport and key open spaces.

Radiating from the local centre and the high density residential area, Mixed Housing Urban Zone extends across the low lying lands on the valley floor. To the west, the residential density of MHU transits down to address the stream edge of the right arm of Mahurangi River. This transition of residential density supports a compact urban form around the growth node in Warkworth South whilst enabling a mix of medium-density residential uses with high amenities.

Land Use Metrics & Yield

The proposed masterplan identifies a logic land use pattern which supports efficiency, appropriate balance of land use distribution and diversity of residential opportunities.

The key land use and yield metrics identified by the indicative masterplan are outlined in the chart on the right. As such the land use pattern:

- Contributes to the residential needs and supports a compact urban form
- The appropriate mix of residential zones enables the ability to provide for a wide range of housing choices
- Supports a functional local centre to provide for convenience needs for the residential areas of the site and the wider community within the southern growth area in Warkworth
- Allows the retention of significant ecological areas, remnant bush and more localised landscape features to be integral part of the development
- Ensure high amenity open spaces are generously provided throughout the development

Zoning		Land Area (Hectare)	Percentage of Total Site Area	Residential Yield	Indicative Open Space Provisions (Hectare)
	Terrace housing and Apartment Buildings	19.600	19.70%	367 lots +105 Apartments	1.171
Residential	Mixed Housing Urban	38.393	38.59%	352 lots	9.781
	Large Lot	14.654	14.73%	23 lots	0
	Sub-total	72.647	73.02%	742 lots +105 Apartments	10.952
Dusinasa	Local Centre	3.415	3.43%	68 Apartments	0
Business	Sub-total	3.415	3.43%	68 Apartments	0
	Open Space - Conservation	5.718	5.75%		5.718
Open Space	Sub-total	5.718	5.75%		5.718
Demal	Rural-Mixed Rural	15.233	15.31%		
Rural	Sub-total	15.233	15.31%		
	Others (Existing road/streams/ watercourses/ possible landtake)	2.480	2.49%		
	Total	99.49	100.00%	742 lots +173 Apartments	16.67

Figure 29 - Land Use Metrics and Yields

6.6 Open Space Strategy


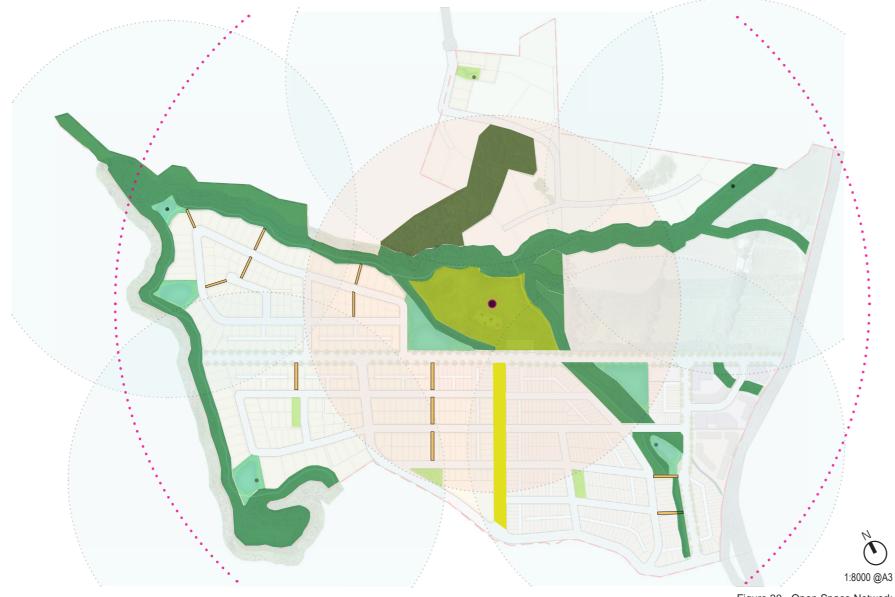


Figure 30 - Open Space Network

The proposed masterplan is based on providing for a variety of generous open spaces across the site to create an integrated network of parks and green links. The open space strategies aim to :

- Enhance the existing ecological corridors along the upper reaches of Mahurangi River and its primary tributaries through generally 20m wide riparian margins
- Create a significant suburb park that provides a variety of high amenity public spaces
- Create a central green avenue to connect Valerie Close with the major park and strengthen the key visual connections to the landscape on the northern hills
- Provide for a series of pocket parks within the urban grain of the residential areas
- Create linear green spaces that connects to the riparian corridors and parks
- · Offer continuous, interlinked and safe routes for pedestrians and cyclists to all open spaces
- Integrate stormwater management facilities with public open spaces to enhance the ecological and amenity values of the development
- Protect and enhance the existing forest areas and Morrison's Heritage Orchard



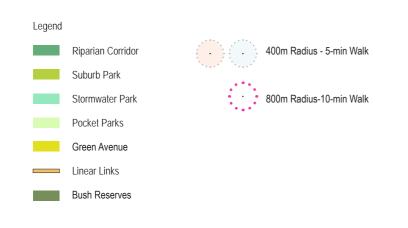








6.7 Street Network

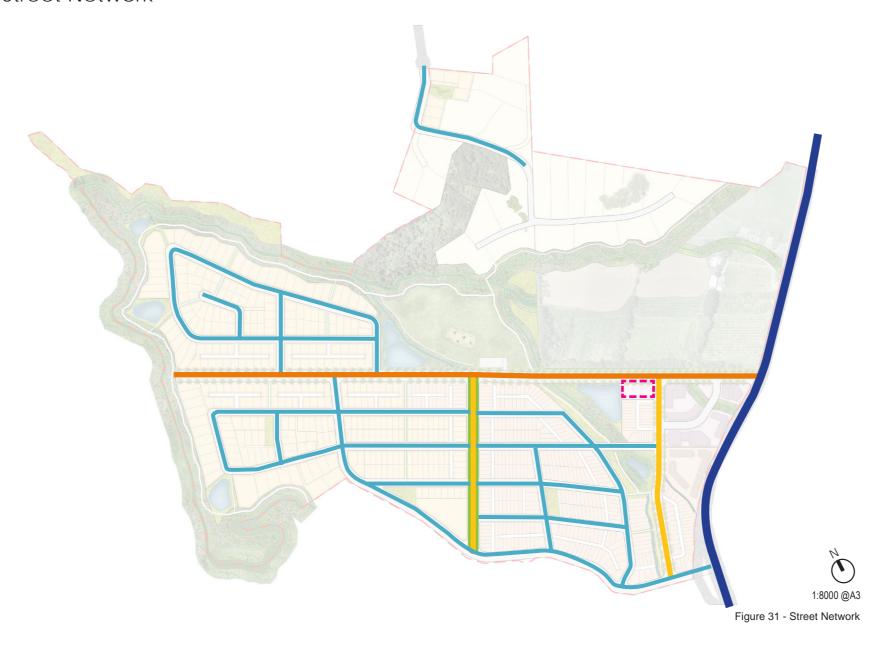

Legend State Highway 1 Arterial Road (24m) Collector Road Green Avenue Local Road Proposed Public Transport Interchange

Examples of streets

Collector Road



Boulevard




Local Road




Indicative Road Cross-sections


State Highway 1 (24m-2 Lanes)

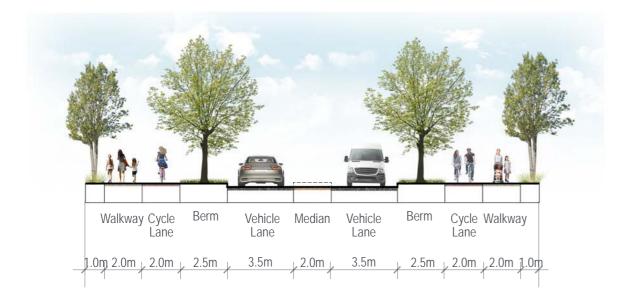

Wider Western Link Road (24m) -Morrison Orchard Section

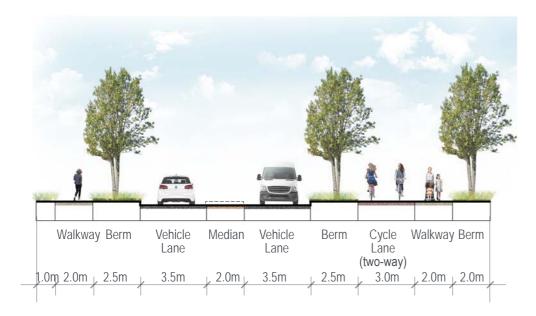


Wider Western Link Road (24m) -Western Section

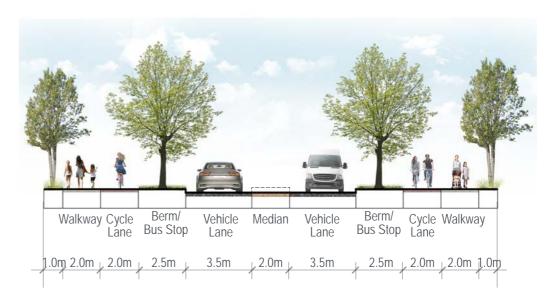


Indicative Road Cross-sections




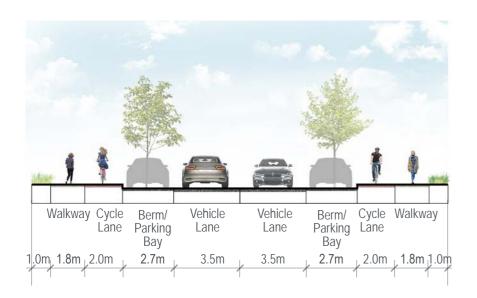

Green Avenue (26m)

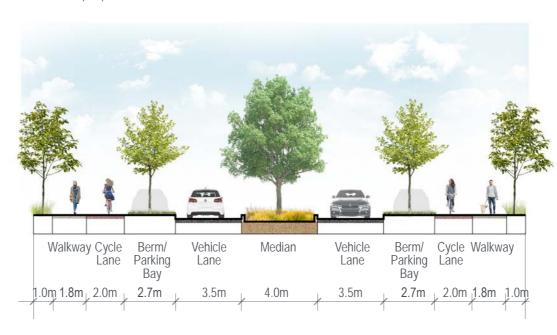

Typical Local Road (17m)

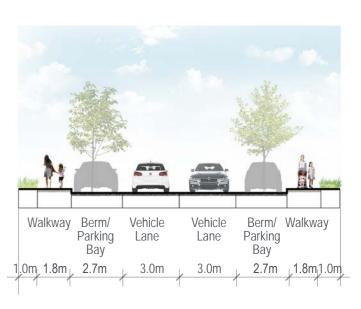

6.8 Walking & Cycling Network



The Waimanawa masterplan places a strong emphasis on creating a walkable community.

Footpaths and on-road cycle routes are integrated within the road reserves to provide primary pedestrian and cycle access across the site. The routes are legible and offers direct connections to the local centre, public transport interchange and open spaces.

A pedestrian and cyclist crossing will be provided at the intersection of SH1 and WWLR to connect the western and eastern sites.

The open spaces within the masterplan area are interlinked and well connected with the proposed local centre and residential community through both on-road walking and cycling routes and off-road recreational paths.

A serious of shared pedestrian and cycle paths are generously provided alongside Mahurangi River and its tributaries. The boulevard provides direct pedestrian and cycle linkages between the proposed WWLR and Valerie Close as well as visual connections towards the central park and bush reserves on the northern slopes.

Figure 32 - Walking & Cycling Network



6.9 Landscape Approach



Figure 33 - Landscape Concept



Planting Strategy

The natural valley setting of the Waimanawa site in south Warkworth, includes an existing necklace of wetland/riparian planting and well established native forest along the corridor of the central stream (a tributary of the upper reaches of the Mahurangi River).

The central intention of the landscape design for the site is to retain all established indigenous species, within both the riparian/wetland and forest areas and to extend these into the planned new wetlands, streams, reserve areas and streets.

The dominant tree species of the existing forest remnant and riparian vegetation are kanuka, pūriri, totara, rimu, kahikatea, kauri, pōhutukawa and many vines and epiphytes.

Recent landuse has been a mixture of pastoral farming, orchards, and vineyards.

Little care has been provided to the existing riparian and forest plantings. Pest plants existing within these areas, will require eradication and management prior to any infill or succession planting commences.

Expansion of the forest and wetlands into the new plantings in the reserves, wetland areas and streets will integrate the development with the existing landscape..

The proposed new stormwater ponds provide not only an opportunity to integrate with the existing riparian and wetland plantings, but to soften the transition to the residential community dwellings.

The planned reserve areas at the base of the valley feature extensive wetlands and provide additional opportunity to celebrate the past use of the land of food source, by integrating community gardens and fruit trees.

Open space of the planned reserve areas will allow for active use by the community, for play, sports, recreation and an active travel pathway. All the streets will feature berm plantings of trees with a majority of indigenous species mixed with exotics chosen for their hardy and seasonal attributes.

The double planting of the heavy volume arterial road with large exotic plane tree species, will have instant scale impact, to provide the need to slow down for traffic, as it enters this community zone.

Large grade indigenous tree species, such as the Totara, Kowhai, and Pūriri will feature in the berms of the residential streets providing themed character to each street.

Future design guidelines will provide elements such as fencing, and amenity plantings, with pathways, allowing for clear visual access across plantings.

Plantings are also chosen to provide a diverse mix of both exotic for pollination of other plants, food source for birds, reptiles, insects, and frog species by wetland enhancement and expansion of riparian and forest species into the necklace of rich texture existing on the boundaries of the site.

Low riparian plants are specifically selected to maintain a clear corridor along the Mahurangi River for bats to flying through.

Example of Riparian Edge















Indicative Planting Palette

Streetscape Planting

Area	Category	Botanic Name	Common Name
		Sophora chathamica	Coastal kōwhai
		Prunus yedoensis 'Awanui'	Flowering Cherry
	Specimen Trees	Liquidambar styraciflua 'Worplesdon'	Sweet Gum
		Vitex lucens	Purriri
		Platanus x acerifolia	London Plane
Arterial Road		Phormium cookianum 'Emerald Green'	Dwarf Mountain Flax
Arteriai Kuau		Libertia grandiflora	NZ Iris
		Phormium 'Dark Delight'	Ornamental Flax
	Amneity Planting	Hebe species	Hebe
		Griselinia littoralis	Kapuka / Broadleaf
		Muehlenbeckia complexa	Small-leaved Pohuehue
		Carex secta	Makura Sedge

Seclection of Aetrial Road Planting



Sophora chathamica Coastal kōwhai



Prunus yedoensis 'Awanui' Flowering Cherry



Liquidambar styraciflua 'Worplesdon' Sweet Gum



Vitex lucens Purriri



Platanus x acerifolia London Plane



Phormium cookianum 'Emerald Green' 'Dwarf Mountain Flax



Libertia grandiflora NZ Iris



Phormium 'Dark Delight' 'Ornamental Flax



Hebe 'Wiri Mist' Koromiko / Hebe



Carex secta 'Makura Sedge

Indicative Planting Palette

Streetscape Planting

Area	Category	Botanic Name	Common Name
		Meryta sinclairii	Puka/Pukanui
		Rhopalostylis sapida 'Chathamica'	Chatham Island Nikau
	Specimen Trees	Rhapalostylis sapida	Nikau Palm
		Sophora chathamica	Coastal kōwhai Flowering Cherry NZ Daphne
		Prunus yedoensis 'Awanui'	
Local Centre		Pimelea prostrata	NZ Daphne
Local Cernie		Pseudopanax arboreus	Five Finger
		Pseudopanax ferox	Fierce Toothed Lancewood
	Amneity Planting	Sophora molloyii 'Dragons Gold'	Ornamental Kowhai
		Tecomanthe speciosa	Three Kings Vine
		Pratia angulata	Panakenake
		Coprosma 'Taiko'	Groundcover coprosma

Area	Category	Botanic Name	Common Name
		Prunus 'Tai Haku'	Great White Flowering Cherry
		Prunus yedoensis 'Awanui'	Flowering Cherry
	Specimen Trees	Rhopalostylis sapida 'Chathamica'	Chatham Island Nikau
		Alectryon grandis	Three Kings titoki
		Sophora microphylla	South Island Kowhai
Davilavand		Muehlenbeckia complexa	Small-leaved Pohuehue
Boulevard		Hebe species	Hebe
		Asplenium 'Maori Princess'	Hybrid Fern
	Amneity Planting	Coprosma 'Taiko'	Groundcover coprosma
		Dianella nigra	Turutu
		Libertia grandiflora	NZ Iris
		Pratia angulata	Panakenake

Selection of Local Centre Planting







Rhopalostylis sapida 'Chathamica' Pim Chatham Island Nikau NZ



Pimelea prostrata NZ Daphne



Sophora molloyii 'Dragons Gold' Ornamental Kowhai

Selection of Boulevard Planting



Sophora microphylla South Island Kowhai



Alectryon grandis Three Kings titoki



Prunus 'Tai Haku' Great White Flowering Cherry



Muehlenbeckia complexa Small-leaved Pohuehue



Hebe salicifolia 'Snowdrift' Koromiko / Hebe



Dianella nigra Turutu



Asplenium 'Maori Princess' Hybrid Fern



Pratia angulata Panakenake

Indicative Planting Palette

Streetscape Planting

Area	Category	Botanic Name	Common Name
		Podocarpus 'Matapouri Blue'	Blue Totara
		Phyllocladus trichomanoides	Tanekaha
	Specimen Trees	Vitex lucens	Purriri
		Carpodetus serratus	Putaputaweta / Marble Leaf
		Laurelia novae-zelandiae	Pukatea
Collector Road		Phormium cookianum 'Emerald Green'	Dwarf Mountain Flax
Collector Road		Phormium 'Dark Delight'	Ornamental Flax
		Choisya ternata	Pukatea Dwarf Mountain Flax Ornamental Flax Mexican Orange Blossom Groundcover coprosma
	Amneity Planting	Coprosma 'Prostrata'	Groundcover coprosma
		Hebe species	Hebe
		Pimelea prostrata	NZ Daphne
		Pittosporum 'Golf Ball'	Dwarf Pittosporum

Area	Category	Botanic Name	Common Name
		Sophora tetraptera	North Island Kowhai
		Magnolia grandiflora 'Little Gem'	Evergreen Magnolia
	Specimen Trees	Olea europaea	Fruiting Olive Fruiting Apple Fruiting Apricot Star Jasmine Dwarf Box Hedge
		Apple tree	
		Apricot tree	
Residential Street		Trachelospermum jasminoides	Star Jasmine
Residential Street		Buxus 'Green Gem'	Dwarf Box Hedge
		Buxus 'Graham Blandy'	Upright Box
	Amneity Planting	Rosmarinus 'Lockwood de Forest'	Groundcover Rosemary
		Acaena purpurea	Purple Bidibidi
		Ajuga reptans 'Jungle Beauty'	Bugleherb
		Pimelea prostrata	NZ Daphne

Area	Category	Botanic Name	Common Name
		Fraxinus angustifolia 'Raywoodii'	Claret Ash
	Specimen Trees	Magnolia grandiflora 'Little Gem'	Evergreen Magnolia
		Prunus yedoensis 'Awanui'	Flowering Cherry
Low Density Stree		Phormium cookianum 'Emerald Green'	Dwarf Mountain Flax
	Amneity Planting	Phormium 'Surfer'	Ornamental Flax
	Ammeny Planting	Ajuga reptans 'Jungle Beauty'	Bugleherb
		Coprosma 'Prostrata'	Groundcover coprosma

Selection of Collector Road Planting



Podocarpus 'Matapouri Blue' Blue Totara



Phyllocladus trichomanoides Tanekaha



Choisya ternata Mexican Orange Blossom



Pittosporum 'Golf Ba Dwarf Pittosporum

Selection of Residential Street Planting



Sophora tetraptera North Island Kowhai



Magnolia grandiflora 'Little Gem' Evergreen Magnolia



*Trachelospermum jasminoides*Star Jasmine



Buxus 'Green Gem' Dwarf Box Hedge

Selection of Low Density Street Planting



Fraxinus angustifolia 'Raywoodii' Claret Ash



Prunus yedoensis 'Awanui' Flowering Cherry



Phormium cookianum 'Emerald Gree 'Dwarf Mountain Flax



Phormium 'Surfer Ornamental Flax

Stormwater Pond Planting

V	U	ソ

Category	Botanic Name	Common Name
	Carex secta	Makura Sedge
	Apodasmia similis	Oioi
	Phormium tenax	Harakeke / NZ Flax
	Coprosma robusta	Karamu
	Hebe salicifolia	Koromiko / Hebe
SHURBS	Carex virgata	Pukio / Swamp Sedge
SHUKDS	Carex geminata	Rautahi / Wetland Cutty Grass
	Coprosma propinqua	Mingimingi
	Austroderia fulvida	Toe Toe
	Macropiper excelsum	Kawakawa
	Pseudopanax arboreus	Five Finger
	Aristotelia serrata	Makomako / Wineberry
	Cordyline australis	Cabbage Tree
	Dacrycarpus dacrydioides	kahikatea
	Pittosporum tenuifolium	Kohuhu / Black Matipo
TREES	Pittosporum crassifolium	NZ Karo
	Podocarpus totara	Totara
	Leptospermum scoparium	Manuka
	Kunzea ericoides	Kanuka

Selection of Stormwater Pond Planting







Apodasmia similis Oioi



Phormium tenax Harakeke / NZ Flax



Coprosma robusta Karamu



Carex virgata
Pukio / Swamp Sedge



Pittosporum tenuifolium Kohuhu / Black Matipo



Makomako / Wineberry



Austroderia fulvida Toe Toe



Cordyline australis Cabbage Tree



Pittosporum tenuifolium Kohuhu / Black Matipo



Leptospermum scoparium Manuka



Kunzea ericoides Kanuka

Common Name

Dwarf Box Hedge

North Island Kowhai

Evergreen Magnolia Fruiting Apple

London Plane

Fruiting Apricot

Fruiting Fig

Riparian Planting

Category	Botanic Name	Common Name
	Phormium tenax	Harakeke / NZ Flax
	Carex secta	Makura Sedge
	Apodasmia similis	Oioi
	Coprosma robusta	Karamu
	Carex virgata	Pukio / Swamp Sedge
SHURBS	Austroderia fulvida	Toe Toe
SHUKBS	Macropiper excelsum	Kawakawa
	Pseudopanax arboreus	Five Finger
	Aristotelia serrata	Makomako / Wineberry
	Coprosma propinqua	Mingimingi
	Sophora molloyii 'Dragons Gold'	Ornamental Kowhai
	Pseudopanax lessonii	Native Five Finger
	Cordyline australis	Cabbage Tree
	Dacrycarpus dacrydioides	kahikatea
	Pittosporum tenuifolium	Kohuhu / Black Matipo
TREES	Pittosporum crassifolium	NZ Karo
	Podocarpus totara	Totara
	Leptospermum scoparium	Manuka
	Carpodetus serratus	Putaputaweta / Marble Leaf

Parks & Common Areas Planting

Botanic Name

Buxus 'Green Gem'

Sophora tetraptera

Apple tree Apricot tree

fig tree

Platanus x acerifolia

Magnolia grandiflora 'Little Gem'



Category

TREES





f

Pittosporum 'Golf Ball' Dwarf Pittosporum Hebe species Hebe Sophora molloyii 'Dragons Gold' Ornamental Kowhai Phormium cookianum 'Emerald Green' Dwarf Mountain Flax Phormium 'Dark Delight' Ornamental Flax SHURBS Ornamental Flax Phormium 'Surfer' Rosmarinus 'Lockwood de Forest' Groundcover Rosemary Trachelospermum jasminoides Star Jasmine Griselinia littoralis Kapuka / Broadleaf Camellia species Camellia Muehlenbeckia complexa Small-leaved Pohuehue Liquidambar styraciflua 'Worplesdon' Sweet Gum

Selection of Riparian Planting



Podocarpus totara Totara



Putaputaweta / Marble Leaf



Carex secta Makura Sedge



Sophora molloyii 'Dragons Gold' Ornamental Kowhai

Selection of Common Area Planting



Buxus 'Green Gem' Dwarf Box Hedge



Phormium 'Dark Delight' 'Ornamental Flax



Platanus x acerifolia London Plane



Magnolia grandiflora 'Little Gem' Evergreen Magnolia

Bat Flight Corridor Planting

9	

Category	Botanic Name	Common Name
	Phormium tenax	Harakeke / NZ Flax
	Carex secta	Makura Sedge
	Apodasmia similis	Oioi
	Hebe species	Hebe
GRASSES &	Carex virgata	Pukio / Swamp Sedge
SHURBS	Austroderia fulvida	Toe Toe
SHUKDS	Macropiper excelsum	Kawakawa
	Astelia fragrans	Kakaha / Bush Flax
	Astelia nervosa 'Westland'	Bronze Bush Flax
	Coprosma propinqua	Mingimingi
	Sophora molloyii 'Dragons Gold'	Ornamental Kowhai

Selection of Bat Flight Corridor Planting



Astelia fragrans Kakaha / Bush Flax



Hebe 'Wiri Mist' Koromiko / Hebe



Carex secta Makura Sedge



Sophora molloyii 'Dragons Gold' Ornamental Kowhai





Drawing List SK-010 Location Plan SK-014 Existing Site Plan - Aerial SK-015 Existing Site Plan - Existing Zones SK-100 Proposed Masterplan - Aerial Proposed Masterplan - Overall SK-103 SK-105 Proposed Masterplan - North SK-106 Proposed Masterplan - South SK-110 Proposed Masterplan - Existing Structure Plan Overlay Proposed Masterplan - Proposed Zoning Overlay SK-111 SK-120 Proposed Masterplan - Natural Features Proposed Masterplan - Tree Retention Classification Overlay - North SK-121 SK-122 Proposed Masterplan - Tree Retention Classification Overlay - South SK-125 Proposed Masterplan - Proposed Transport SK-130 Proposed Area Plan - North SK-131 Proposed Area Plan - South SK-132 Proposed Area Schedule Grand total: 16

Project Name:

Warkworth - South

Project Address:

Client Name: NZPC

Project Number: 2114
Project Date: March 2021


SKHY Level 4, 38 Khyber Pass Road, Grafton, Auckland 09 302 3689 PO Box 44376 Point Chevalier Auckland 1022 www.astudioarchitects.com

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FEASIBILITY

Pavisian & Data

Revision & Date	
∘A Feasibility	2021-03-18
∘B Feasibility	2021-08-31
○ C Feasibility	2021-10-14
○ D Feasibility	2021-11-03
∘E Feasibility	2021-12-14
∘ F Feasibility	2022-02-22
∘G Feasibility	2022-03-24
○H Feasibility	2023-05-01

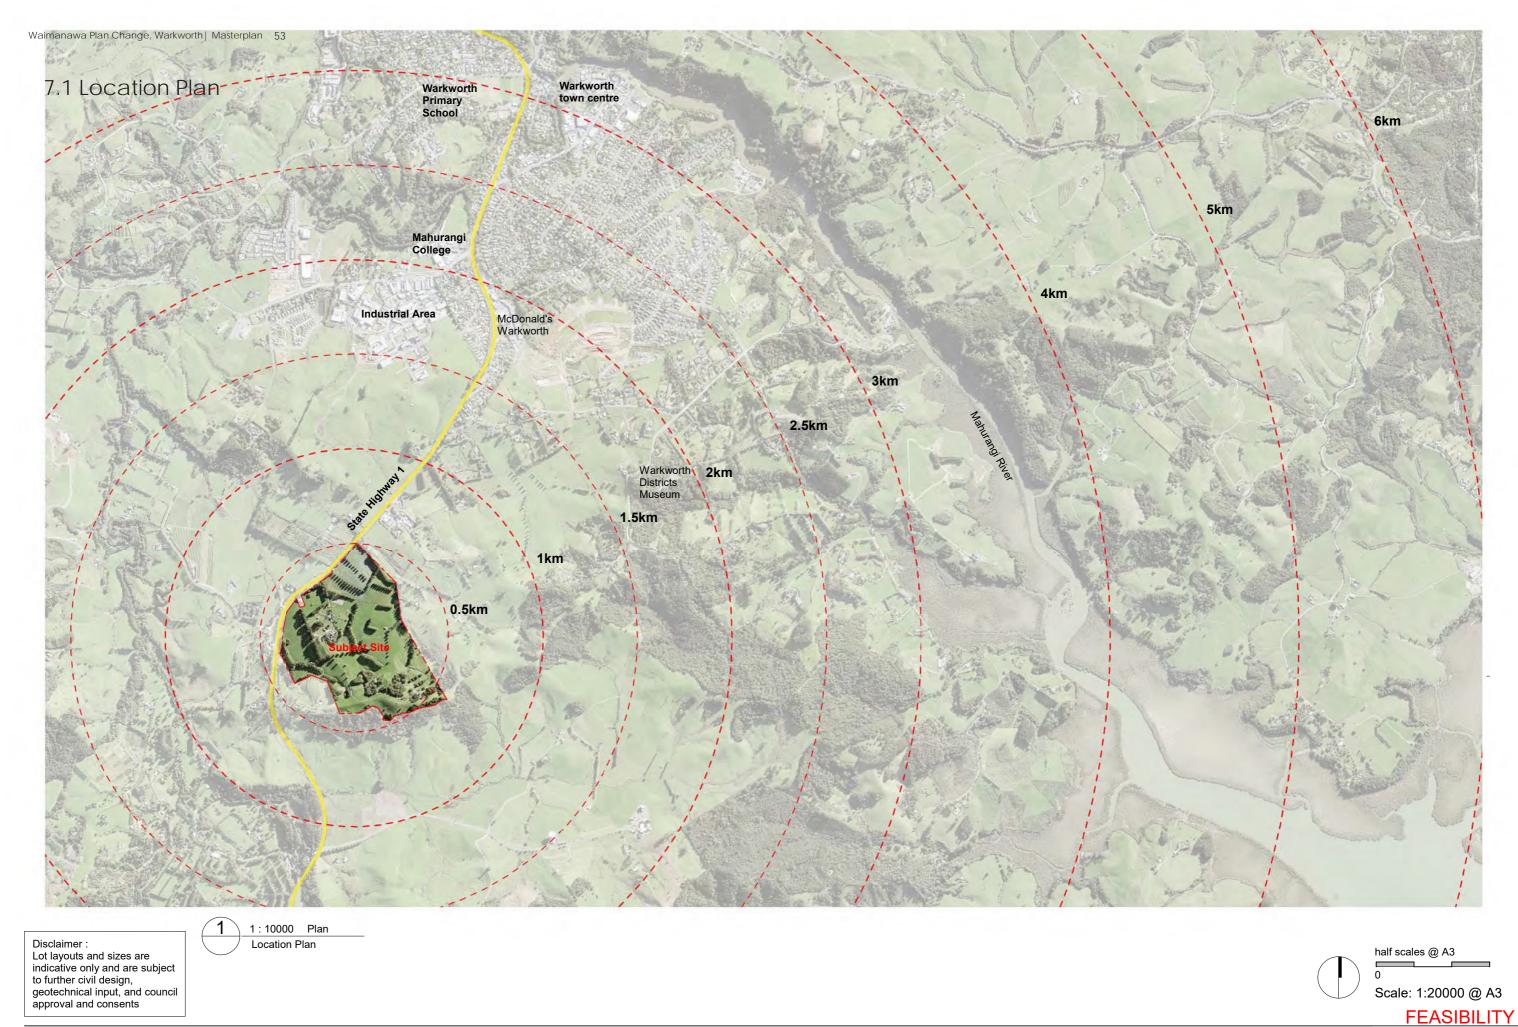

March 2021

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Warkworth - South

Location Plan

Drawing No: Rev SK-010 A

Revision A

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7.2 Existing Site Plans



Lot Area = 473,300m²

Existing levels from GIS

half scales @ A3

Disclaimer:
Lot layouts and sizes are
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to further civil design,
geotechnical input, and council
approval and consents

Warkworth - South


Existing Site Plan - Aerial


Drawing No: SK-014 Project No: 2114

 $\overset{\text{Revision}}{C}$

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Scale: 1:5000 @ A3



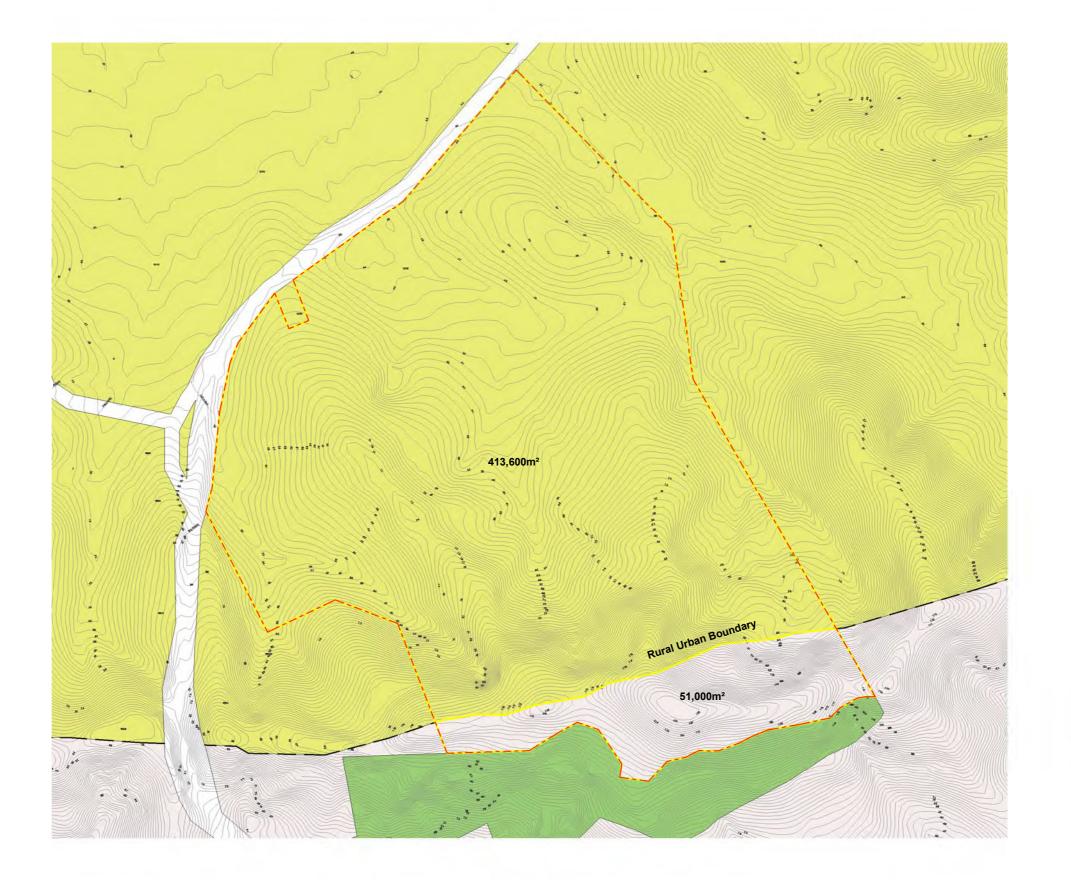

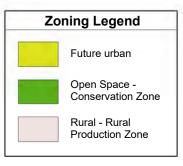Note: Contour lines at 1m interval

half scales @ A3

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Existing Site Plan - Existing Zones

Drawing No: SK-015 Project No: 2114

Revision В

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Scale: 1:5000 @ A3

7.3 Proposed Masterplan



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Drawing No: SK-100 Project No: 2114

Revision G

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Scale: 1:5000 @ A3

half scales @ A3



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Warkworth - South

Drawing No: SK-103

Revision

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Scale: 1:5000 @ A3

half scales @ A3

Proposed open space



indicative only and are subject to further civil design, geotechnical input, and council approval and consents

Scale: 1:2500 @ A3

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Drawing No: SK-105 Project No: 2114 Revision Ε

FEASIBILITY A STUDIO **ARCHITECTS**



March 2021


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Warkworth - South

Proposed Masterplan - South

Drawing No: SK-106 Project No: 2114

Revision F A STUDIO ARCHITECTS

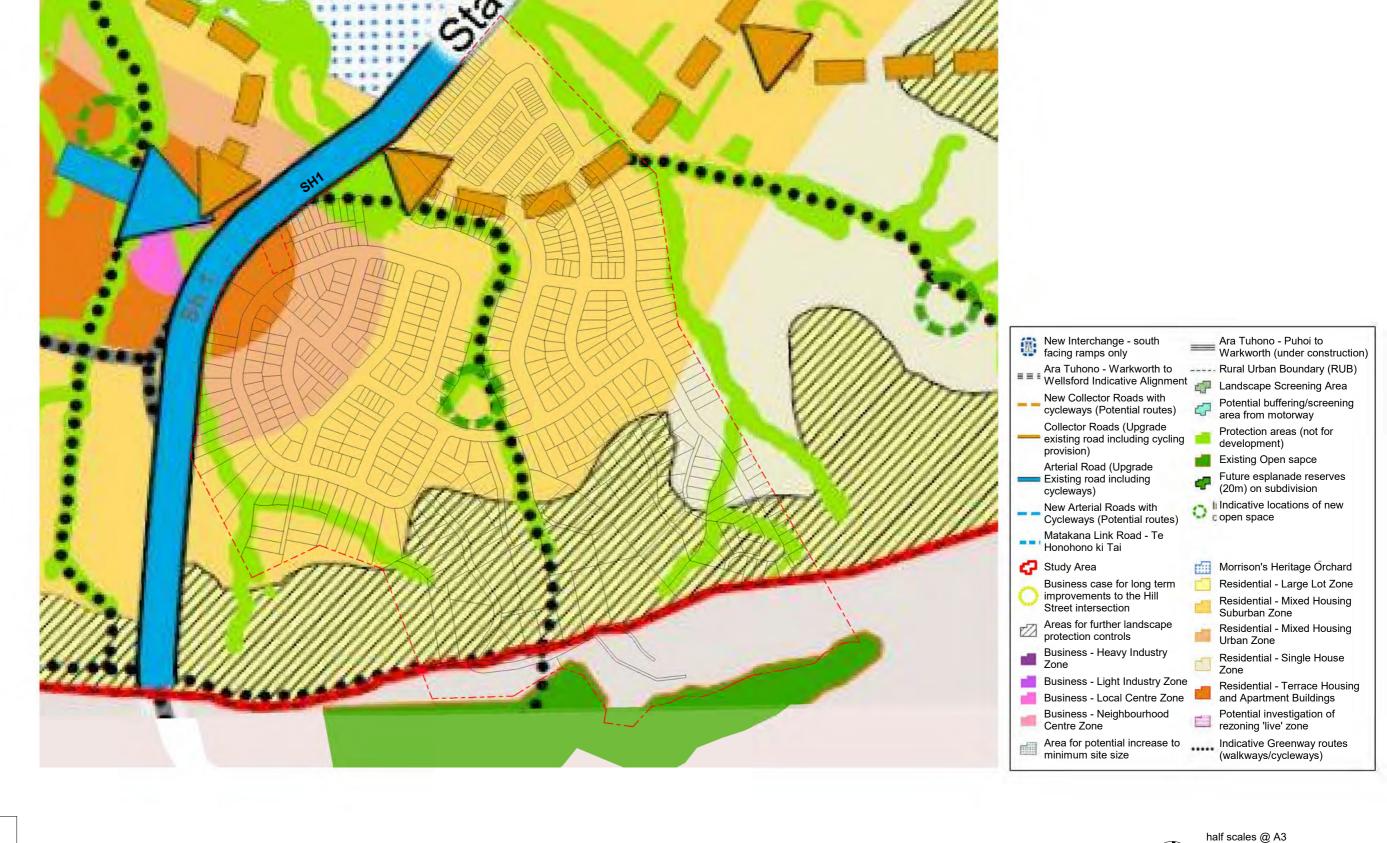

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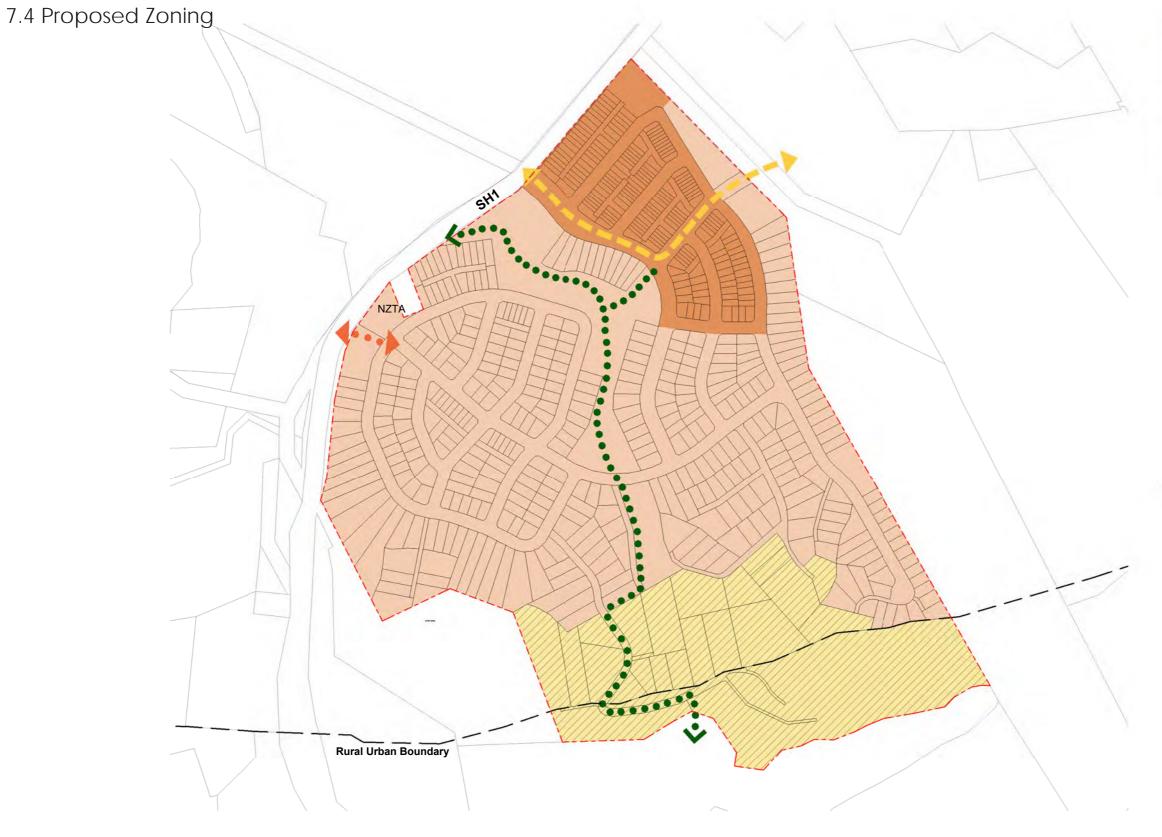
Warkworth - South


Proposed Masterplan - Existing Structure Plan Overlay

Drawing No: SK-110

FEASIBILITY Revision A STUDIO **ARCHITECTS**

Scale: 1:5000 @ A3



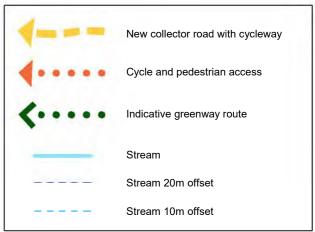

Zoning Summary	
Low Density Residential Zone Minimum lot size 1000m²	23
Mixed Housing Urban Zone	396
Terrace Housing and Apartment Buildings Zone	183
Total	602

Zoning Area Percentage								
Zone	Area	Percentage						
Terrace Housing and Apartment Building Zone	57785.7 m²	12.4%						
Mixed Housing Urban Zone	302215.8 m ²	65.0%						
Low Density Residential Zone - Minimum lot size 1000m²	104684.6 m²	22.5%						
	464686.1 m ²	100.0%						
	464686.1 m²	100.0%						

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Proposed Masterplan - Proposed Zoning Overlay

Drawing No: SK-111

Revision

FEASIBILITY A STUDIO **ARCHITECTS**

half scales @ A3

Scale: 1:5000 @ A3

7.5 Natural Features



Stream 20m offset as identified by Maven Stream 10m offset as identified by Maven Tree numbers from the Arborist Report Existing trees to be removed Refer to **SK-121** &122 for the classification of the existing trees to be retained Proposed plan is shown overlaid with existing contours, shown at 1m interval.

Existing trees to be retained

Stream as identified by Maven

Site with covenant to be

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March 2021

Drawing No: SK-120

Revision D

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Scale: 1:5000 @ A3

half scales @ A3



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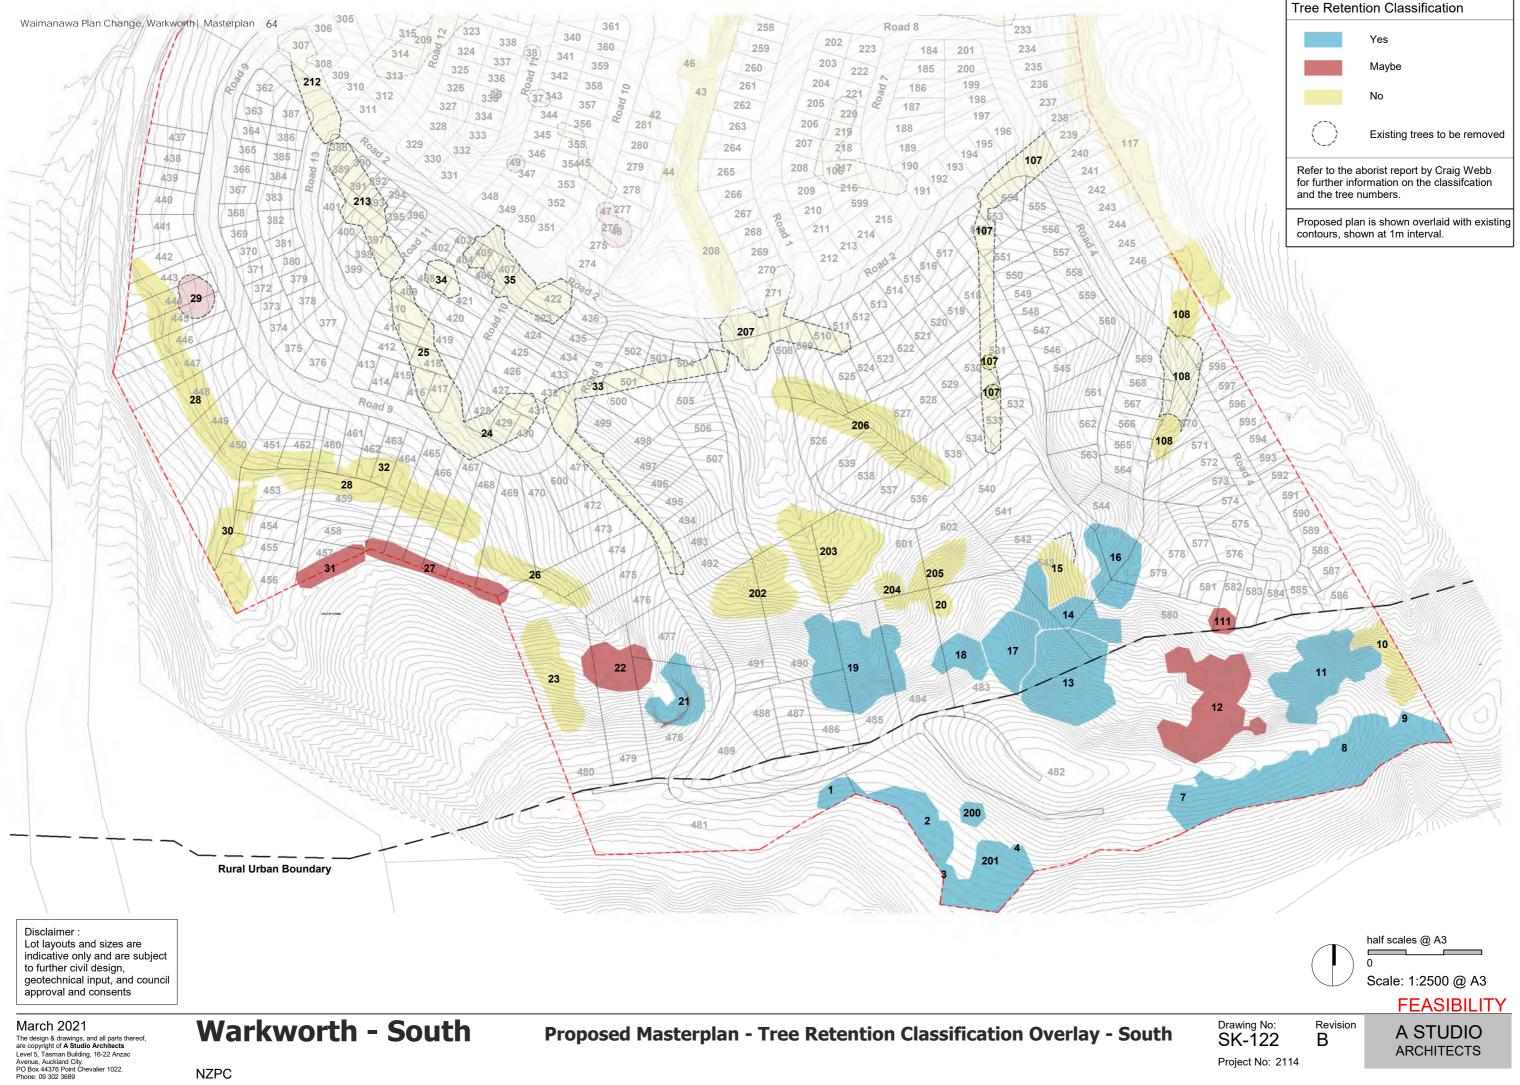
Warkworth - South

Proposed Masterplan - Tree Retention Classification Overlay - North

Drawing No: SK-121 Project No: 2114

Revision В


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Project No: 2114

ARCHITECTS

7.6 Transport



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Proposed Masterplan - Proposed Transport

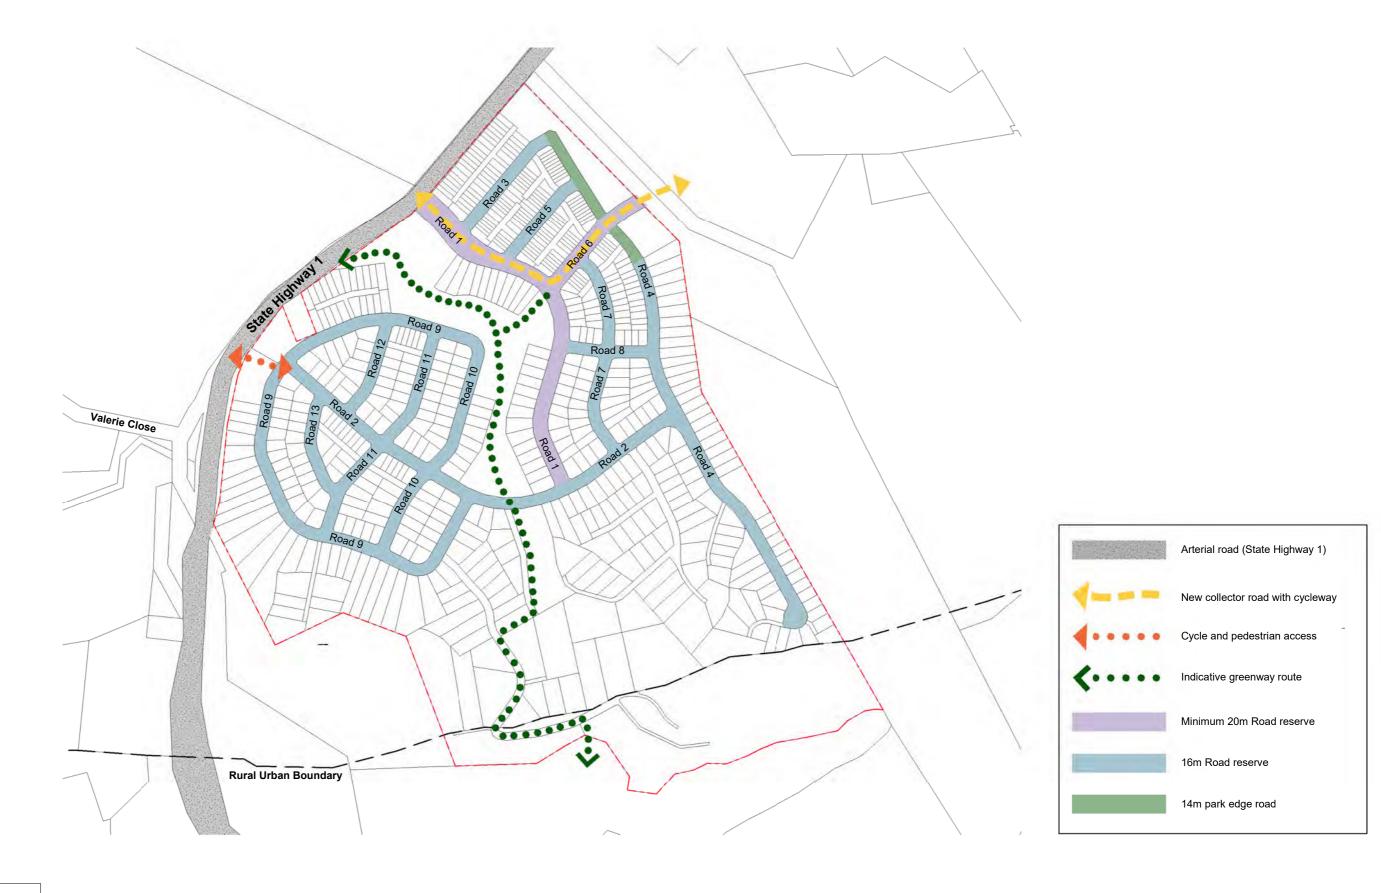Drawing No: SK-125 Project No: 2114 Revision D

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half scales @ A3

Scale: 1:5000 @ A3

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half scales @ A3

Scale: 1:2500 @ A3

FEASIBILITY

March 2021

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Phone: 09 302 3689

Warkworth - South

Proposed Area Plan - North

Drawing No: 5K-130
Project No: 2114

Revision D

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Lot layouts and sizes are indicative only and are subject to further civil design, geotechnical input, and council approval and consents

Scale: 1:2500 @ A3

FEASIBILITY

Color Colo	Lot Area	Schedule	Lot Area	a Schedule	Lot Area	a Schedule	Lot Area	a Schedule	Lot Area	Schedule	Lot Area Schedule		Lot Area Schedule		Lot Area Schedule		Lot Area Schedule		Lot Area Schedule		1
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14.5 m 1	Lot 3	148.2 m²	Lot 63	99.0 m²	Lot 123	132.0 m²	Lot 183	258.4 m²	Lot 243		Lot 303	444.4 m²	Lot 363	352.2 m²	Lot 423	407.8 m²	Lot 483	6032.0 m ²	Lot 543	1292.6 m²	l
According Acco	Lot 4	148.6 m²	Lot 64	99.0 m²	Lot 124	132.0 m²	Lot 184	332.1 m²	Lot 244	483.0 m²	Lot 304	433.4 m²	Lot 364	312.0 m ²	Lot 424	425.3 m ²	Lot 484	3000.7 m ²	Lot 544	3036.8 m²	1
	Lot 5	148.9 m²		132.0 m²	Lot 125	99.0 m²		359.4 m²	I .	489.0 m²	Lot 305		1	312.0 m ²	I	427.7 m²	I	2646.0 m²	Lot 545	804.0 m²	l
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Let 19 153 0 m² Let 19 153 0 m² Let 190 150 0 m² Let 190 90 0 m² Let 290 90 0 m² Let	Lot 17	153.2 m²	Lot 77	133.1 m²	Lot 137	251.8 m²	Lot 197	510.5 m²	Lot 257	453.5 m²	Lot 317	219.0 m ²	Lot 377	565.6 m²	Lot 437	514.4 m²	Lot 497	683.2 m²	Lot 557	432.0 m²	1
Lot 20 154 m² Lot 80 90 m² Lot 140 204 m² Lot 200 300 m² Lot 200 427 l m² Lot 200 427 l m² Lot 200 427 l m² Lot 200 300 m² Lot 440 204 m² Lot 200 300 m² Lot 420 427 m² Lot 200 427 m² Lot 200 m²	Lot 18	153.5 m²	Lot 78	176.0 m²	Lot 138	160.5 m²	Lot 198	416.8 m²	Lot 258	422.2 m²	Lot 318	164.3 m²	Lot 378	407.5 m²	Lot 438	518.8 m²	Lot 498	731.6 m²	Lot 558	432.0 m²	1
Lot 22 323.7 m² Lot 81 99.0 m² Lot 141 1993.7 m² Lot 251 320.1 m² Lot 252 403.7 m² Lot 252 403.7 m² Lot 252 403.7 m² Lot 253 300.0 m² Lot 440.0 m² Lot 430 400.0 m² Lot 430 400.0 m² Lot 430 300.0 m² Lot 243 300.0 m²	Lot 19	153.9 m²	Lot 79	132.0 m²	Lot 139	160.5 m²	Lot 199	323.2 m²	Lot 259	424.7 m²	Lot 319	166.9 m²	Lot 379	312.0 m ²	Lot 439	519.8 m²	Lot 499	715.8 m²	Lot 559	541.4 m²	1
Lut 22 323.1 m² Lut 182 98.0 m² Lut 142 1676 m² Lut 232 328.6 m² Lut 233 350.0 m² Lut 243 168.7 m² Lut 233 350.0 m² Lut 244 144.0 m² Lut 144 152.0 m² Lut 145 169.5 m² Lut 233 350.0 m² Lut 245 159.0 m²	Lot 20	154.1 m²	Lot 80	99.0 m²	Lot 140	I	I	330.7 m²	Lot 260	I	Lot 320		1	I	Lot 440	640.7 m ²	I		Lot 560		1
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Lot 28 192.0 m² Lot 88 99.0 m² Lot 184 189.0 m² Lot 299 399.3 m² Lot 299.3 m² Lot 299 399.3 m² Lot 299.3 m² Lot 299						I	I .	I	- 1		1		1		- 1		I				1
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Lot 35 2 18.0 m²	Lot 33	144.0 m²	Lot 93	100.4 m²	Lot 153	204.9 m²	Lot 213	360.6 m²	Lot 273	420.0 m ²	Lot 333	350.7 m ²	Lot 393	176.0 m²	Lot 453	1368.8 m²	Lot 513	447.4 m²	Lot 573	509.9 m²	1
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Lot 37	Lot 35	216.0 m ²	Lot 95	100.4 m²	Lot 155	159.3 m²	I	I	Lot 275	373.8 m²	Lot 335	312.0 m ²	1	I	Lot 455	661.8 m²	Lot 515	411.7 m²	Lot 575	589.0 m²	l
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Disclaimer:
Lot layouts and sizes are
indicative only and are subject
to further civil design,
geotechnical input, and council
approval and consents

half scales @ A3

March 2021

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PO Box 44376 Point Chevalier 1022.
Phone: 09 302 3689

Warkworth - South

Proposed Area Schedule

Drawing No: SK-132

Revision Ε



Lot Area Schedule

Lot 601 3641.5 m² Lot 602 2010.1 m² Grand total: 602

Area

Lot#

7.8 Landscape Approach

Landscape Design typologies



Legend

Riparian Corridor

Community Park

Pocket Park

Stormwater Pond

Native Revegetation

Open Space Strategy

The proposed masterplan provides a variety of open spaces across the site to create an integrated network of parks and green links. The open space strategies aim to :

- Enhance the existing ecological corridors along the upper reaches of Mahurangi River and its primary tributaries through riparian planting
- Create a series of central community parks that provides a variety of high amenity public spaces
- Create a central green spine connecting the development to the Avice Miller Scenic Reserve on the southern boundary.
- Highlighting the existing tributaries and native tree stands on site
- Offer continuous, interlinked, and safe routes for pedestrians and cyclists to all open spaces
- Integrate stormwater management facilities with public open spaces to enhance the ecological and amenity values of the development
- Protect and enhance the Avice Miller Scenic Reserve, create community connection

Examples of Open Spaces



Community Park



Pocket Parl

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Stormwater Park



Riparian Corridor

Landscape Design typologies



Legend Streetscape Planting

Main Road Planting

Collector Road Planting

Residential Street Planting

JOAL Planting

Streetscape Planting Strategy

Collector Road Planting: The collector roads within the development are typified by the large scale native and exotic species selected. The large deciduous exotic species assist in preserving the rural character of the Site and provide seasonal change and scale to the wide roads. The native species selected reflect the endemic species of the Site and provide habitat for native fauna.

Main Road Planting: A largely native tree palette is utilised along the main roads within the development, relating to the endemic species of the Site, providing year round greenery and shade to the streets whilst providing habitat for native fauna, and connection to the Avice Miller Scenic Reserve.

Residential Street Planting: A mix of medium sized native and exotic trees species line the residential streets providing a mix of colours and textures. Fruit species provide a link to the Historic Morrisons Orchard across State Highway 1 in addition to seasonal change and edible fruit to the residential streets. Selected native species relate to those identified on site by the arborist providing habitat for native fauna, and connection to the Avice Miller Scenic Reserve.

JOAL Planting: Native and exotic trees species line the residential streets providing a mix of colours and textures. Deciduous exotic species assist in preserving the rural character of the Site and provide seasonal change. Selected native species relate to those identified on site by the arborist providing habitat for native fauna, and connection to the Avice Miller Scenic Reserve.

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Landscape Design typologies



Legend

Amenity Planting







Stormwater Pond



Native Enhancement Planting Strategy

The large site contains open farmland, a large number of shelter belts and agro-forestry plantings, native bush-clad areas, and a centrally located homestead surrounded by amenity plantings. The site has gentle gradients over much of the area, but rises steeply towards a ridgeline to the south. Three tributaries of the Upper reaches of the Mahurangi River incise the site and are buffered by largely exotic species.

The intention of the landscape design is to retain all established stands of indigenous species and largely remove all exotic species unless they provide significant rural value to the Site. Indigenous stands should be enhanced through native revegetation planting of existing riparian/wetland and forest areas and extend into the planned new wetlands, streams, reserve areas and streets.

The dominant tree species of the existing forest remnant and riparian vegetation are pūriri, totara, rimu, kahikatea, kauri, pōhutukawa and associated vines and epiphytes.

Recent landuse has been a mixture of pastoral farming, and horse stables.

Existing riparian and forest areas have been neglected. Pest plants existing within these areas, will require eradication and management prior to any infill or succession planting commences.

Expansion of the forest and wetlands into the new reserves, wetland areas and streets will integrate and enhance the existing landscape.

The proposed new stormwater ponds provide an opportunity to integrate with the existing riparian and wetland areas softening the transition to the residential community dwellings.

Open space of the planned reserve areas will allow for active use by the community, for play, sports, recreation and an active travel pathway.

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Streetscape Planting

Area	Category	Botanic Name	Common Name
		Podocarpus totara	Totara
		Knightia excelsa	Rewarewa
	Specimen Trees	Liquidambar styraciflua 'Worplesdon'	Sweet Gum
		Vitex lucens	Puriri
		Platanus acerifolia	London Plane
Collector Road		Phormium green dwarf Dwarf Mou	Dwarf Mountain Flax
Collector Road		Libertia sp.	NZ Iris
		Phormium 'Dark delight'	Hybrid Flax
	Amenity Planting	Hebe sp.	Kiromiko
		Griselinia littoralis	Kapuka
		Muehlenbeckia complexa	Pohuehue
		Carex secta	Sedge

Area	Category	Botanic Name	Common Name
		Podocarpus totara	Totara
		Dacrycarpus dacrydioides	Kahikatea
	Specimen Trees	Vitex lucens	Puriri
		Sophora microphylla	Kowhai
		Lourelia novae-zealandiae	Pukatea
Main Dood		Phormium dwarf green	Dwarf Mountain Flax
Main Road		Phormium dark delight	Hybrid Flax
		Muehlenbeckia astonii	Shrubby Tororaro
	Amenity Planting	Coprosma prostrata	Ground cover coprosma
		Hebe sp.	Kiromiko
		Pimelea protrata	NZ daphne ground cover
		Pittosporum golf ball	dwarf pittosporum hybrid





















Streetscape Planting

Area	Category	Botanic Name	Common Name
		Olea europaea	Olive
		Malus 'Domestica'	Apple
	Specimen Trees	Prunus armeniaca	Apricot
		Sophora tetraptera	Kowhai
		Magnolia grandiflora little gem	Magnolia
Residential Street		Muehlenbeckia axillaris	Pohuehue
Nesiderillar Street		Coprosma repens 'Poor Knights'	Taupata
		Libertia Sp.	NZ Iris
	Amenity Planting	Carex virgata	Pukio
		Acaena inermis purpures	Purple Bidibidi
		Astelia chathamica 'Silver Spear'	Hybrid Astelia
		Pimelia prostrate	NZ daphne

Area	Category	Botanic Name	Common Name
		Meryta sinclarii	Puka
		Rhopalostylis sapida 'chathamica'	Chatham Island nikau
	Specimen Trees	Acer palmatum 'Senkaki'	Coral Bark Maple
		Sophora chathamica	Chatham Island Kowhai
		Prunus yedoensis 'Awanui'	Yoshino Cherry
JOAL		Pimelia prostrata	NZ Daphne
		Pseudopanax arboreus	NZ five finger
		Psuedopanax ferrox	Lancewood
	Amenity Planting	Sophora dragons gold	Hybrid Kowhai
		Tecomanthe speciosa	Three Kings Climber
		Lobelia angulata	Panakenake
		Coprosma taiko	Groundcover coprosma





















Parks & Common Areas Planting

Category	Botanic Name	Common Name
	Buxus 'Green Gem'	Dwarf Box Hedge
	Pittosporum 'Golf Ball'	Dwarf Pittosporum
	Hebe species	Hebe
	Sophora molloyii 'Dragons Gold'	Ornamental Kowhai
	Phormium cookianum 'Emerald Green'	Dwarf Mountain Flax
SHURBS	Phormium 'Dark Delight'	Ornamental Flax
SHUKDS	Phormium 'Surfer'	Ornamental Flax
	Rosmarinus 'Lockwood de Forest'	Groundcover Rosemary
	Trachelospermum jasminoides	Star Jasmine
	Griselinia littoralis	Kapuka / Broadleaf
	Camellia species	Camellia
	Muehlenbeckia complexa	Small-leaved Pohuehue
	Liquidambar styraciflua 'Worplesdon'	Sweet Gum
	Sophora tetraptera	North Island Kowhai
	Platanus x acerifolia	London Plane
TREES	Magnolia grandiflora 'Little Gem'	Evergreen Magnolia
	Apple tree	Fruiting Apple
	Apricot tree	Fruiting Apricot
	fig tree	Fruiting Fig

Stormwater Pond Planting

	Category	Botanic Name	Common Name
d		Carex secta	Makura Sedge
		Apodasmia similis	Oioi
		Phormium tenax	Harakeke / NZ Flax
		Coprosma robusta	Karamu
		Hebe salicifolia	Koromiko / Hebe
	CHILDDC	Carex virgata	Pukio / Swamp Sedge
	SHURBS	Carex geminata	Rautahi / Wetland Cutty Grass
		Coprosma propinqua	Mingimingi
		Austroderia fulvida	Toe Toe
		Macropiper excelsum	Kawakawa
		Pseudopanax arboreus	Five Finger
		Aristotelia serrata	Makomako / Wineberry
		Cordyline australis	Cabbage Tree
		Dacrycarpus dacrydioides	kahikatea
		Pittosporum tenuifolium	Kohuhu / Black Matipo
	TREES	Pittosporum crassifolium	NZ Karo
		Podocarpus totara	Totara
		Leptospermum scoparium	Manuka
		Kunzea ericoides	Kanuka













Riparian Planting

	Category	Botanic Name	Common Name
a		Phormium tenax	Harakeke / NZ Flax
		Carex secta	Makura Sedge
		Apodasmia similis	Oioi
		Coprosma robusta	Karamu
		Carex virgata	Pukio / Swamp Sedge
	SHURBS	Austroderia fulvida	Toe Toe
	SHUKBS	Macropiper excelsum	Kawakawa
		Pseudopanax arboreus	Five Finger
		Aristotelia serrata	Makomako / Wineberry
		Coprosma propinqua	Mingimingi
		Sophora molloyii 'Dragons Gold'	Ornamental Kowhai
		Pseudopanax lessonii	Native Five Finger
		Cordyline australis	Cabbage Tree
		Dacrycarpus dacrydioides	kahikatea
		Pittosporum tenuifolium	Kohuhu / Black Matipo
	TREES	Pittosporum crassifolium	NZ Karo
		Podocarpus totara	Totara
		Leptospermum scoparium	Manuka
		Carpodetus serratus	Putaputaweta / Marble Leaf



Riparian Planting









8.1 Existing Site Features

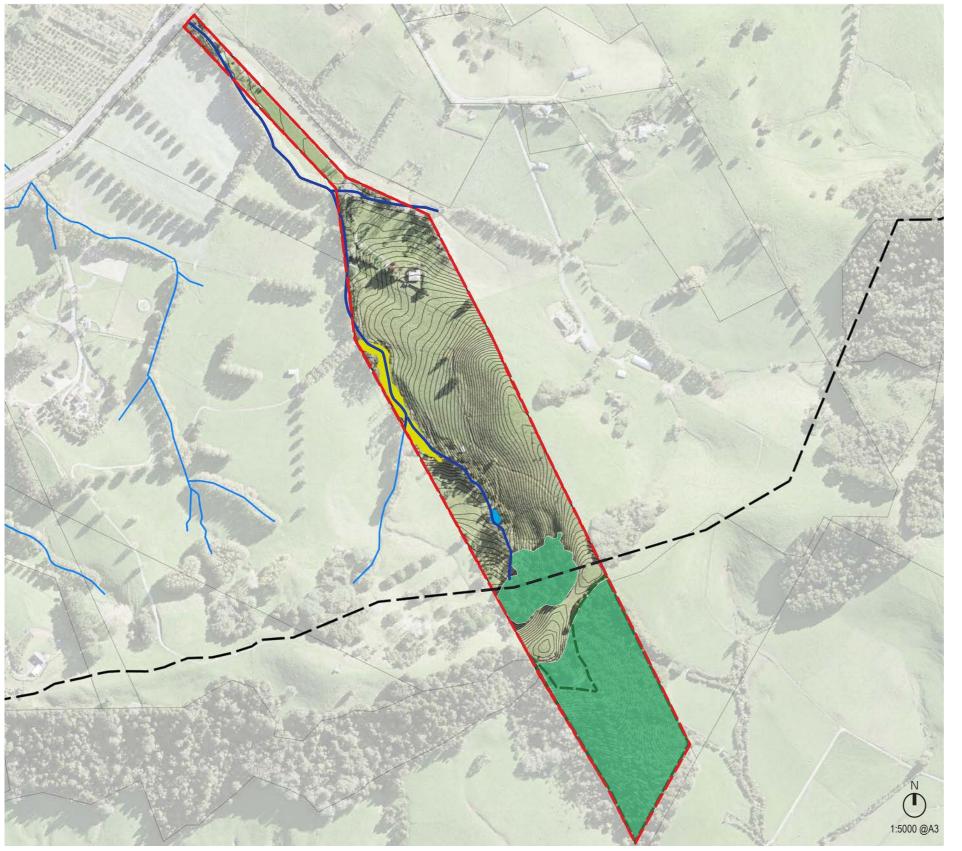


Figure 34 - Waimanawa Hills(b) Existing Site Features



8.2 Proposed Masterplan



Figure 35 - Waimanawa Hills(b) Illustrative Masterplan



8.3 Proposed Zoning

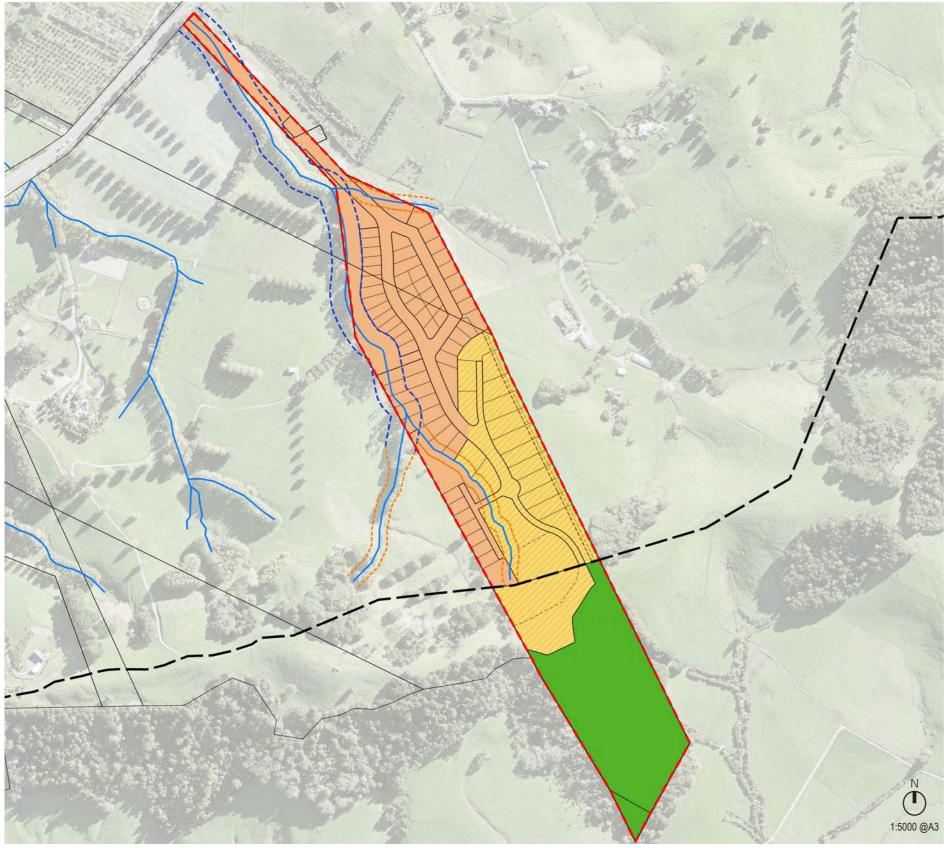


Figure 36 - Waimanawa Hills(b) Zoning Plan



Zoning		Land Area	Percentage
Zoning	(Hecta		
	Mixed Housing Urban	5.628	43.23%
Residential	Low Density Residential	4.012	30.82%
	Sub-total	9.640	74.05%
Onon Chass	Open Space - Conservation	3.378	25.95%
Open Space	Sub-total	3.378	25.95%
	Total	13.02	100.00%

Figure 37 - Waimanawa Hills(b) Zoning Metrics





Figure 39 - Waimanawa Hills(b) Streetscape Planting

Streetscape Planting Strategy

Collector Road Planting: The collector roads within the development are typified by the large scale native and exotic species selected. The large deciduous exotic species assist in preserving the rural character of the Site and provide seasonal change and scale to the wide roads. The native species selected reflect the endemic species of the Site and provide habitat for native fauna.

Residential Street Planting: A mix of medium sized native and exotic trees species line the residential streets providing a mix of colours and textures. Fruit species provide a link to the Historic Morrisons Orchard across State Highway 1 in addition to seasonal change and edible fruit to the residential streets. Selected native species relate to those identified on site by the arborist providing habitat for native fauna, and connection to the Avice Miller Scenic Reserve.

JOAL Planting: Native and exotic trees species line the residential streets providing a mix of colours and textures. Deciduous exotic species assist in preserving the rural character of the Site and provide seasonal change. Selected native species relate to those identified on site by the arborist providing habitat for native fauna, and connection to the Avice Miller Scenic Reserve.



Figure 40 - Waimanawa Hills(b) Open Space

Open Space Strategy

The proposed masterplan provides a variety of open spaces across the site to create an integrated network of parks and green links. The open space strategies aim to :

- Enhance the existing ecological corridors along the upper reaches of Mahurangi River and its primary tributaries through riparian planting
- Create a coupling of pocket parks that provides a variety of high amenity public spaces
- Highlighting the existing tributaries and native tree stands on site
- Offer continuous, interlinked, and safe routes for pedestrians and cyclists to all open spaces
- Protect and enhance the Avice Miller Scenic Reserve, create community connection

Examples of Open Spaces







Riparian Corridor

Streetscape Planting

Area	Category	Botanic Name	Common Name
		Podocarpus totara	Totara
		Knightia excelsa	Rewarewa
	Specimen Trees	Liquidambar styraciflua 'Worplesdon'	Sweet Gum
		Vitex lucens	Puriri
Collector Road		Platanus acerifolia	London Plane
		Phormium green dwarf	Dwarf Mountain Flax
Collector Road		Libertia sp.	NZ Iris
		Phormium 'Dark delight'	Hybrid Flax
	Amenity Planting	Hebe sp.	Kiromiko
		Griselinia littoralis	Kapuka
		Muehlenbeckia complexa	Pohuehue
		Carex secta	Sedge

Area	Category	Botanic Name	Common Name
		Olea europaea	Olive
		Malus 'Domestica'	Apple
	Specimen Trees	Prunus armeniaca	Apricot
		Sophora tetraptera	Kowhai
		Magnolia grandiflora little gem	Magnolia
Residential Street		Muehlenbeckia axillaris	Pohuehue
ixesiderillar street		Coprosma repens 'Poor Knights'	Taupata
		Libertia Sp.	NZ Iris
	Amenity Planting	Carex virgata	Pukio
		Acaena inermis purpures	Purple Bidibidi
		Astelia chathamica 'Silver Spear'	Hybrid Astelia
		Pimelia prostrate	NZ daphne

Area	Category	Botanic Name	Common Name
		Meryta sinclarii	Puka
		Rhopalostylis sapida 'chathamica'	Chatham Island nikau
	Specimen Trees	Acer palmatum 'Senkaki'	Coral Bark Maple
		Sophora chathamica	Chatham Island Kowhai
		Prunus yedoensis 'Awanui'	Yoshino Cherry
JOAL		Pimelia prostrata	NZ Daphne
JUAL		Pseudopanax arboreus	NZ five finger
		Psuedopanax ferrox	Lancewood
	Amenity Planting	Sophora dragons gold	Hybrid Kowhai
		Sophora chathamica Chatham Isla Prunus yedoensis 'Awanui' Yoshino Che Pimelia prostrata NZ Daphne Pseudopanax arboreus NZ five finger Psuedopanax ferrox Lancewood Sophora dragons gold Hybrid Kowh. Tecomanthe speciosa Three Kings Lobelia angulata Panakenake	Three Kings Climber
		Lobelia angulata	Panakenake
		Coprosma taiko	Groundcover coprosma































Parks & Common Areas Planting

Category	Botanic Name	Common Name
	Buxus 'Green Gem'	Dwarf Box Hedge
	Pittosporum 'Golf Ball'	Dwarf Pittosporum
	Hebe species	Hebe
	Sophora molloyii 'Dragons Gold'	Ornamental Kowhai
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SHURBS	Phormium 'Dark Delight'	Ornamental Flax
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	Rosmarinus 'Lockwood de Forest'	Groundcover Rosemary
	Trachelospermum jasminoides	Star Jasmine
	Griselinia littoralis	Kapuka / Broadleaf
	Camellia species	Camellia
	Muehlenbeckia complexa	Small-leaved Pohuehue
	Liquidambar styraciflua 'Worplesdon'	Sweet Gum
	Sophora tetraptera	North Island Kowhai
	Platanus x acerifolia	London Plane
TREES	Magnolia grandiflora 'Little Gem'	Evergreen Magnolia
	Apple tree	Fruiting Apple
	Apricot tree	Fruiting Apricot
	fig tree	Fruiting Fig

Riparian Planting

Category	Botanic Name	Common Name
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	Carex secta	Makura Sedge
	Apodasmia similis	Oioi
	Coprosma robusta	Karamu
	Carex virgata	Pukio / Swamp Sedge
	Austroderia fulvida	Toe Toe
	Macropiper excelsum	Kawakawa
	Pseudopanax arboreus	Five Finger
	Aristotelia serrata	Makomako / Wineberry
	Coprosma propinqua	Mingimingi
	Sophora molloyii 'Dragons Gold'	Ornamental Kowhai
	Pseudopanax lessonii	Native Five Finger
TREES	Cordyline australis	Cabbage Tree
	Dacrycarpus dacrydioides	kahikatea
	Pittosporum tenuifolium	Kohuhu / Black Matipo
	Pittosporum crassifolium	NZ Karo
	Podocarpus totara	Totara
	Leptospermum scoparium	Manuka
	Carpodetus serratus	Putaputaweta / Marble Leaf













